MARY JANE LEE PARK - PHASE II



SALEM, MASSACHUSETTS


KIMBERLEY DRISCOLL, MAYOR



DRAWING LIST

EC 1.0	EXISTING CONDITIONS PLAN
L 1.0	SITE DEMOLITION AND PREP PLAN
L 2.0	MATERIALS PLAN
L 2.1	LAYOUT PLAN
L 3.0	GRADING PLAN
L 4.0	PLANTING PLAN
L 5.0	PAVING DETAILS
L 5.1	FURNISHING DETAILS - BENCHES
L 5.2	FURNISHING DETAILS - SIGNS
L 5.3	FURNISHING DETAILS - FENCES
L 5.4	FURNISHING DETAILS - ADDITIONAL
L 5.5	PLAYBOOSTER DETAILS
L 5.6	PAINTED ASPHALT DETAILS
L 5.7	PLANTING DETAILS
A 100	PAVILION PLANS AND 3-D VIEWS
A 200	ELEVATIONS AND COLUMN DETAILS
A 500	DETAILS
E 0.1	ELECTRICAL SPECIFICATIONS SYMBOLS AND DETAILS
F 1 0	FLECTRICAL SITE PLAN



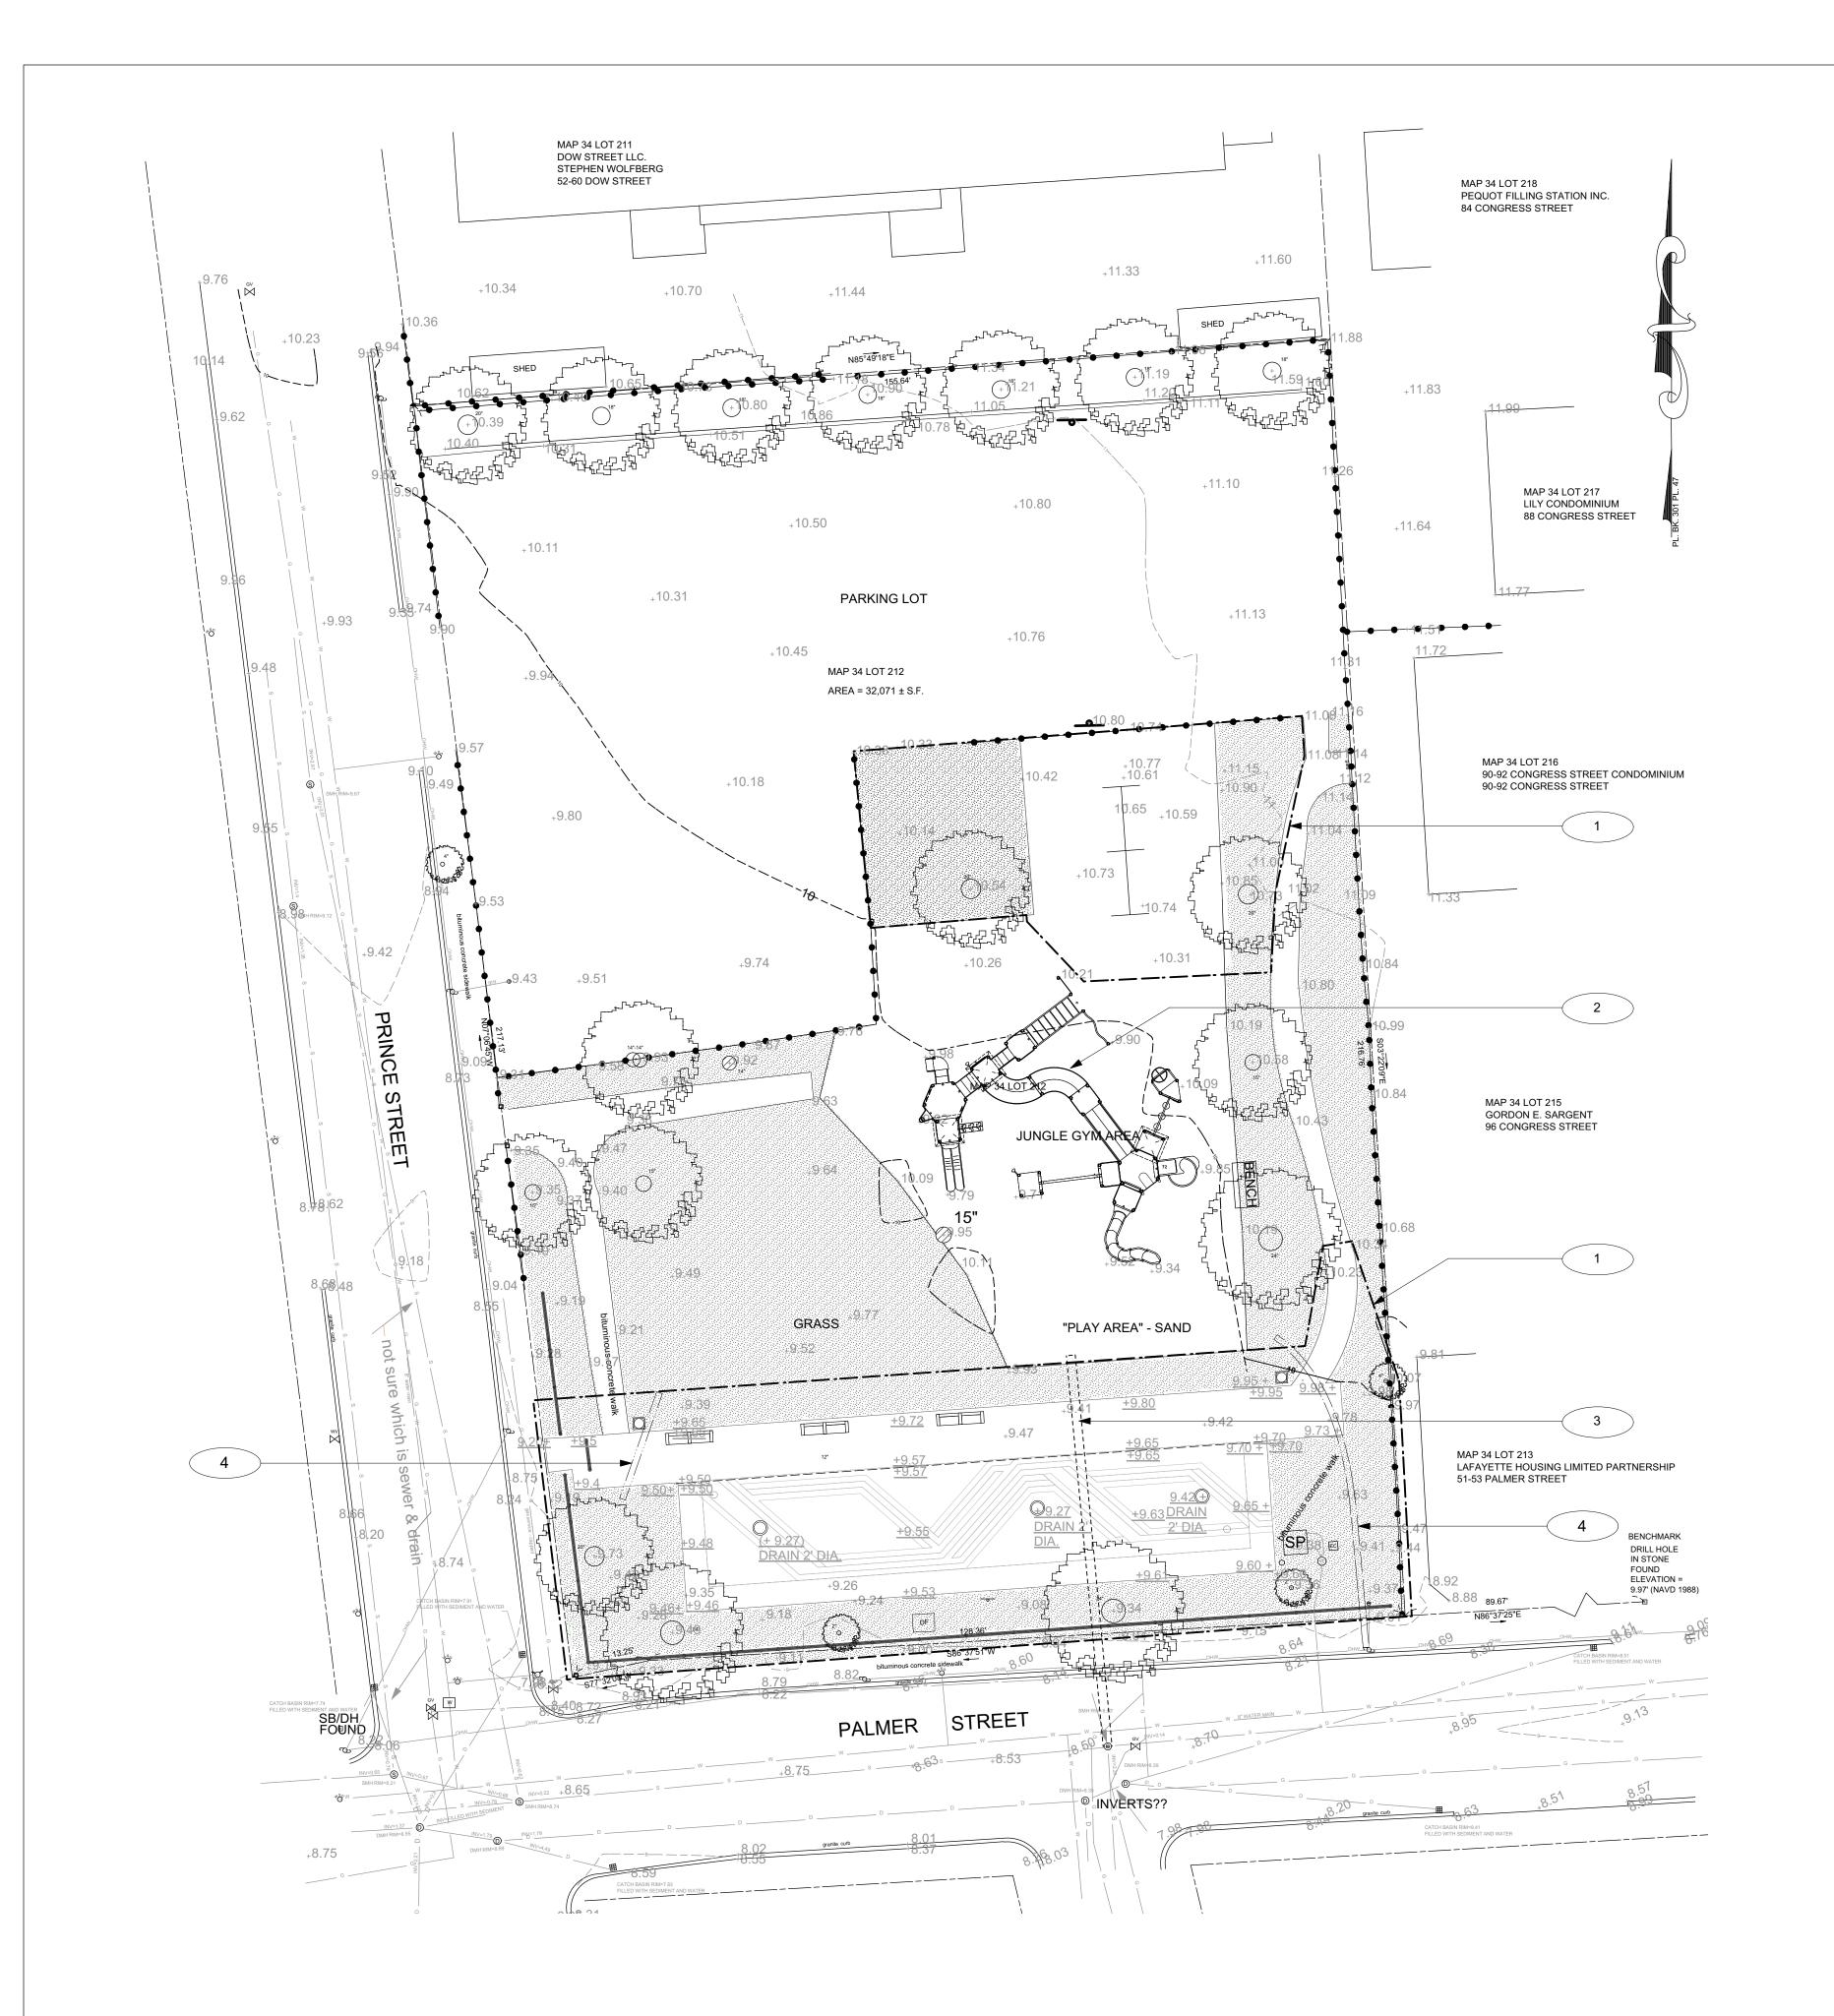

SURVEY NOTES

AND DIAGRAMMATIC ONLY.

Existing conditions and topography data are combined from survey prepared by *North Shore Survey Corporation*, 14 Brown St, Salem, MA, June 6, 2014 and Phase I construction documents.
 Contractor shall verify location of any existing utilities and services and provide protection during construction. Utilities damaged during construction shall be repaired at contractors expense.
 Contractor shall obtain permits for the work as required and comply with all laws, ordinances, rules and regulations of the local jurisdiction, the state, and all other authorities having jurisdiction.
 Contractor shall leave site clean and orderly during construction process. Remove from site all excess materials, soil, debris and equipment. Store materials only in an approved location.
 Contractor to secure site with fence at end of each day's operations.

2. UNDERGROUND UTILITIES ARE SHOWN BASED ON FIELD LOCATIONS,

RECEIVED FROM PETER COPELAS, DATED AUGUST 1, 2001.

PLANS OF OPERATING AUTHORITIES AND A SKETCH OF THE DRAINAGE

DIGSAFE AGENCY SHOULD BE NOTIFIED TO DEMARCATE UNDERGROUND UTILITIES PRIOR TO COMMENCEMENT OF CONSTRUCTION OR EXCAVATION.

THE UTILITIES SHOWN ON THIS PLAN SHOULD BE CONSIDERED APPROXIMATE

EXISTING CONDITIONS REFERENCE NOTES

Plan shows improvements completed in Phase I. This is not an as-built drawing. Contractor to verify site conditions in field.

Play equipment as represented by manufacturers drawing. Exact location to be verified in field.

Approximate location of abandoned, capped

Contractor to field verify location.

EXISTING CONDITIONS LEGEND

Existing Tree

Existing Lawn

Existing Tree Stump

Existing Park Sign

Existing trash can

Chain Link Fence

Existing Major Contour

Existing Minor Contour

Spot Grades from Phase I CDs

Abandoned, capped sewer pipe. (aprox.)

Existing Spot

Electrical Conduit

Exiting Utility Lines

Pipe rail fence

Drain

Existing Drinking fountain

Existing Basketball hoop

Existing bench with back

Existing bench without back

 \bigcirc

SP EC

--10--

--11--

+9.49

+9.57

____ s ___

____ G ____

DESCRIPTION

sewer pipe. Approximate depth 4-5' below grade.

Approximate location of conduit. Contractor to

1. ELEVATIONS ARE BASED ON NAVD OF 1988 DATUM.



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Palmer St

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No. Date Revision

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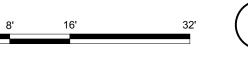


July 20, 2016


PROJECT NUMBER: 1405.1

1/16" = 1'-0"

Existing Conditions
Plan





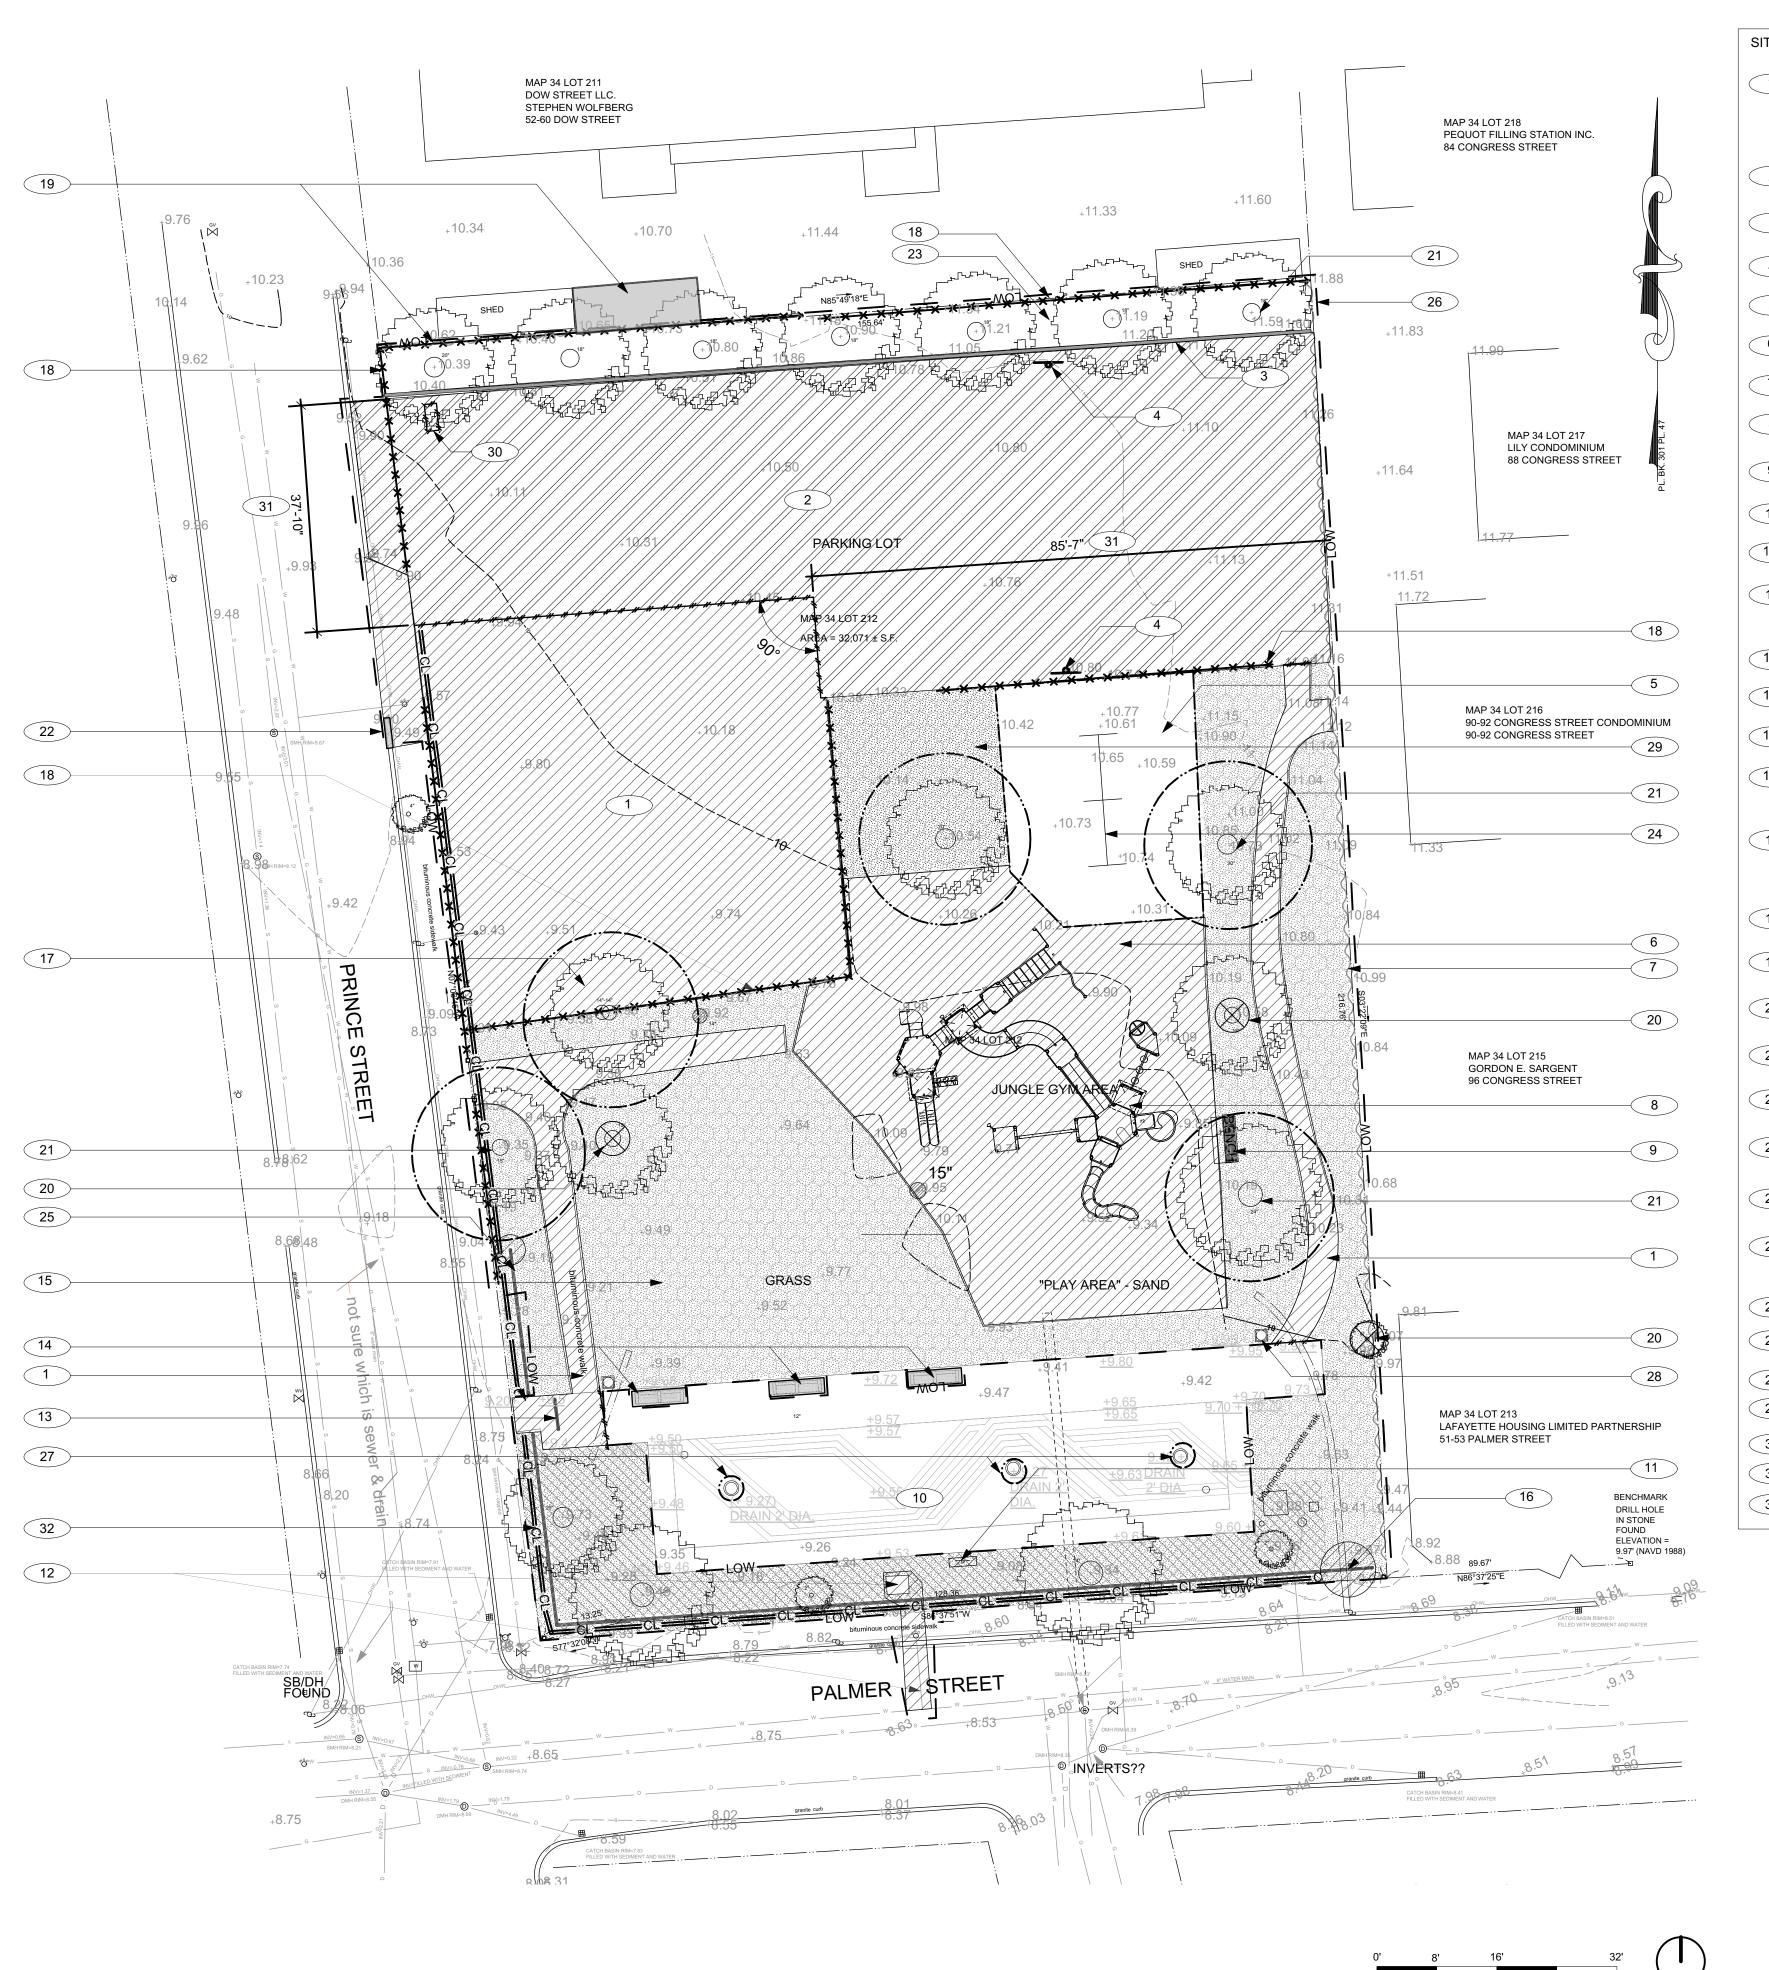

SITE PREP AND DEMO REFERENCE NOTES

Remove Asphalt Parking and Paths Completely, including Base, in areas noted. Saw cut to ensure clean line for remaining asphalt. Contractor to measure and document the existing profile of asphalt in area to remove.

Mill Top Course of Asphalt Parking to Remain, Prep for Resurfacing

Asphalt Curb, Entire Length to Remain; Protect & Assume 10 LF of repair/patching, LA to mark in field

4 Remove Basketball Hoops

5 Protect Play Mulch

6 Remove Play Sand completely. Assume 12" depth, VIF

See 4/L5.3 for instructions on demolition and salvage of chainlink fence on east property line.

See 1/L5.5 for instructions on demolition and salvage of existing play structure.

Remove Wood bench, including footings to at least 6" below finished grade

10 Protect Splash Pad Area During Construction

Remove Park Sign and footing to 6" below finished grade. Salvage Dedication Plaque

Remove existing drinking fountain including footings to at least 6" below finished grade. Remove piping, cut and cap service at water main in street

Remove in-set section of pipe rail

Remove (3) Benches, Stockpile for Reuse. Patch asphalt

15 Strip and Stockpile Topsoil

Remove last pipe rail fence post, footing, and rail section at southeast corner of park and northern end of rail fence. Prep for new post and section.

Paving Removal Within Dripline of Elm Tree to be Done by Hand, See Spec for Root Treatment.
Consult arborist for direction on trimming and limb up tree to allow for sidewalk clearance.

Remove chainlink fence, including posts, rails

Dow Street contractor to remove arbor, top and bottom rails, and mesh of 6' chain link fence. Posts to remain. See 3/L5.3

Remove Tree, pull or grind stump to 6" below grade.

21 Protect all trees to remain. Remove dead wood.

Salvage last segment of curb to re-use for curb cut. Remove asphalt to allow for curb extension.

Clean debris, weeds and volunteer vegetation under trees, prep for mulch.

Existing Swing to remain; prep for repainting and replace seats.

Remove last Pipe Rail Fence post and footing at Northern end of Rail Fence, prep for new post and sections

26 Limit of work.

27 Protect existing drains

28 Existing trash receptacle to remain, protect.


29 Remove 14" below grade to allow for wood mulch

outside limit of tree. See L2.1 for extents

30 Saw cut for bike rack footing. See L2.1 for layout.

31 Verify saw cut dimensions with L2.1

32 Install coir log for erosion control. Detail A, this

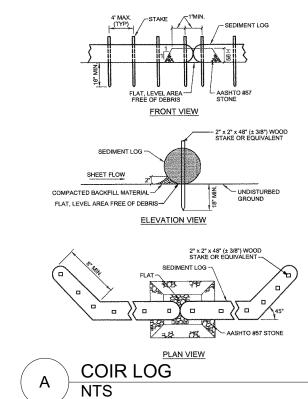



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 Contractor to secure site with fence at end of each day's operations.

SITE DEMOLITION NOTES

 Contractor shall verify all existing conditions in the field and report any discrepancies between plans and actual conditions to Landscape Architect before beginning work.
 Building, structure and paving removal shall include the disconnection and capping of any utilities, footings, slabs, associated base material and satisfactory off-site disposal of all debris produced through the removal operations.

off-site disposal of all stumps vegetative and extraneous debris produced through the removal operations.

4. Existing trees and shrubs to remain shall not be altered without express direction from certified

3. Tree and shrub removal shall include the felling, cutting, grubbing out of roots and satisfactory

arborist and must remain in the same condition as observed prior to construction unless otherwise noted.

5. No heavy machinery is to be used within the root system of existing trees. Excavation within root system zones is to be performed by hand.

system zones is to be performed by hand.
6. Any items scheduled to remain which are damaged by Contractor's operations shall be at Contractor's expense.

be at Contractor's expense.

8. Area for stockpiled items shall be located by Landscape Architect and approved by owner prior to removal operations.

7. Any items scheduled to be stockpiled on site which are damaged by Contractor's operations shall

removal operations.

9. Contractor shall leave work site free of any debris at the end of each day's operations.

10. Contractor shall maintain edge of readway drainage patterns including replacement of payed.

10. Contractor shall maintain edge of roadway drainage patterns including replacement of paved and unpaved swales, berms, and curbs.

11. Contractor is responsible to install temporary and permanent pavement in streets and sidewalks. The contractor shall install temporary pavement on a daily basis and maintain temporary pavement for a minimum of 90 days except if temporary pavement is placed after October 15th, then it shall be maintained util April 15th of the following year unless directed otherwise by the engineer. Temporary centerline pavement paint shall be placed on the temporary pavement wherever existing


SYM.	DESCRIPTION
—_L.O.W.—	Limit of Work
	Property Line
	Strip and Stockpile Topsoil
	Prep for re-seeding
	Remove
	Mill Top Coat
	Salvage
—CL—	Coir Log (DETAIL "A" THIS SHEET)
<i>" " "</i>	Saw Cut
* * *	Chain-link Fence to Remove
~~~	Chain-link Fence - Remove Mesh Only
$\otimes$	Remove Tree
0/	Protect
	Existing Tree
	Existing Tree Stump
	Existing Lawn
<del>-</del> 0-	Existing Park Sign
DF	Existing Drinking fountain
-	Existing Basketball hoop
	Existing bench with back
BENCH	Existing bench without back
	Existing trash can
•	Pipe rail fence
	Asphalt curb
	Drain
SP EC	Utility box
1 <del>0</del>	Existing Major Contour
11	
H	Existing Minor Contour
+9.49	Existing Spot
+9.57	Designed spot (AB)
	Electrical Conduit
	Electrical Conduit
D	



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Date Revision

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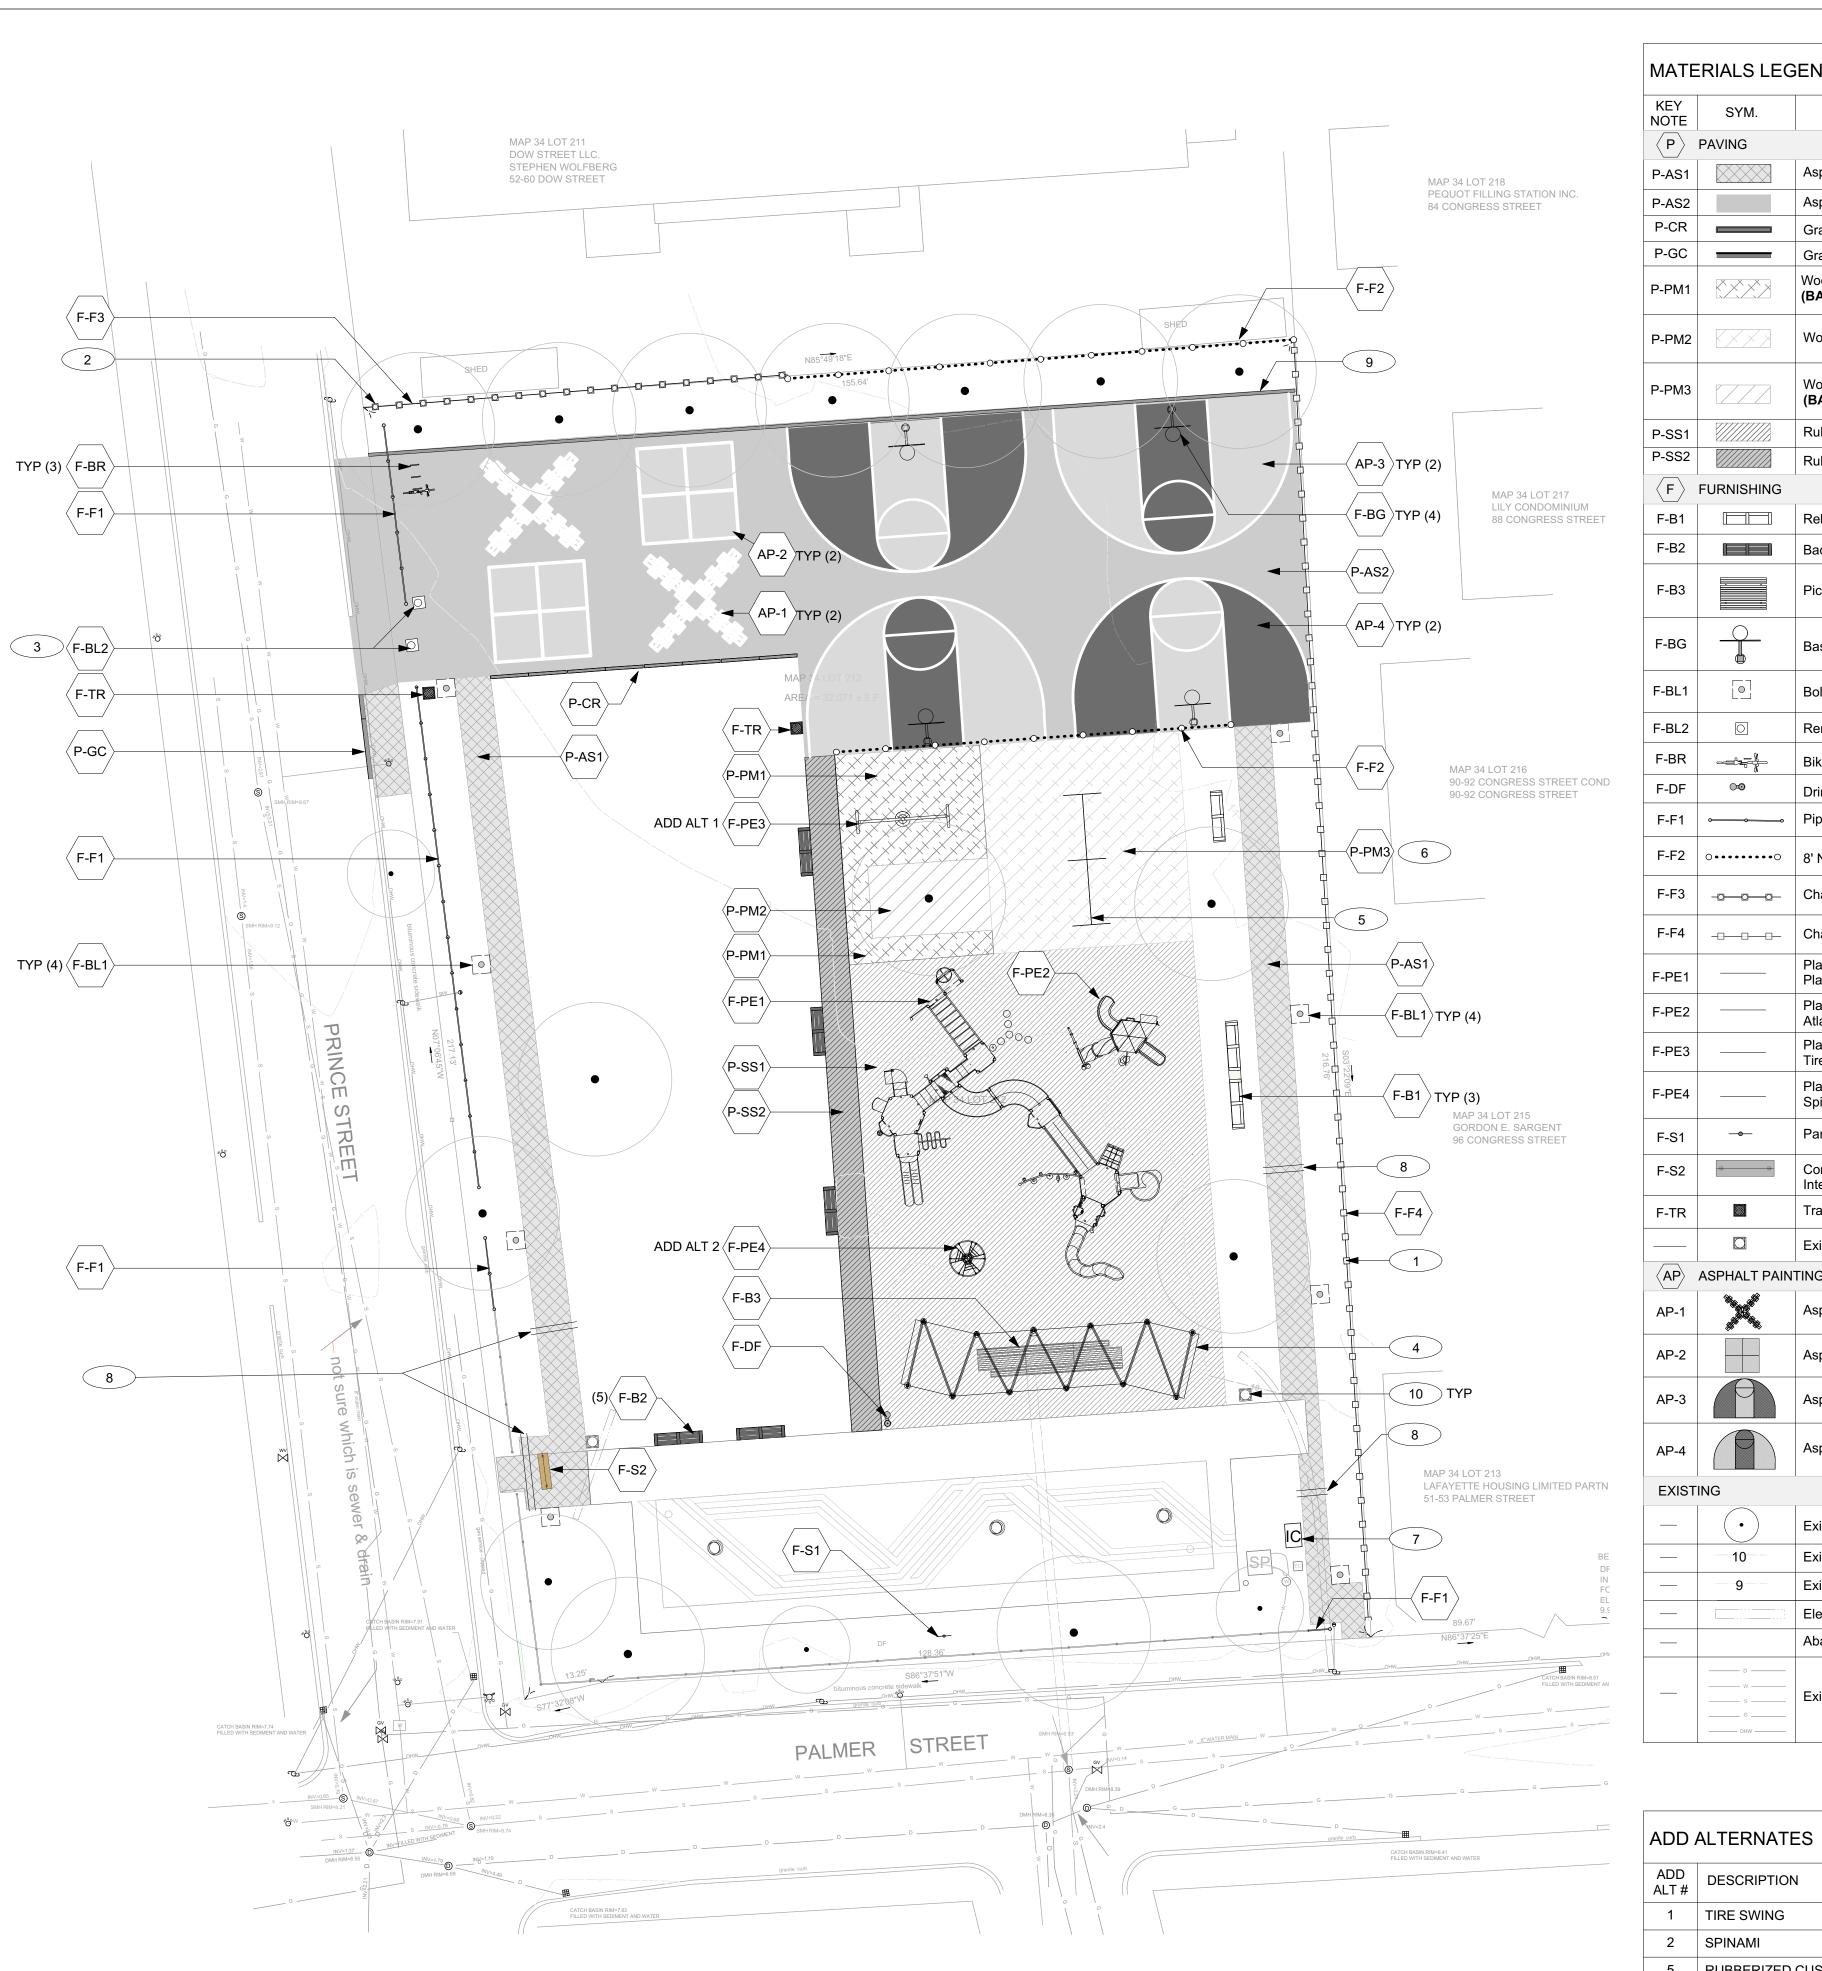
617.338.8400 www.michellecrowley-la.com

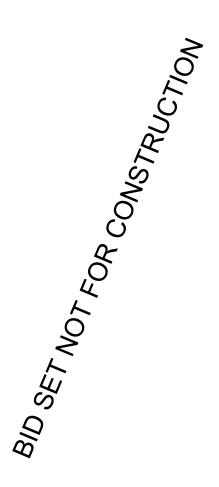

July 20, 2016

Site Preparation and Demolition Plan

L1.0



KEY NOTE	SYM.	DESCRIPTION	DETAIL/ SHEET	SPEC. SECTION
	PAVING			
P-AS1		Asphalt Paving - Pedestrian	1/L5.0	321216
P-AS2		Asphalt Paving - Vehicular	2/L5.0	321216
P-CR		Granite Curb - Raised	6/L5.0	321640
P-GC		Granite Curb	7/L5.0	321640
P-PM1		Wood Fiber Play Surfacing (BASE BID - ADD ALT 5 TO P-SS1)	4/L5.0	321640
P-PM2		Wood Fiber Play Surfacing at Tree	5/L5.0	321817
P-PM3		Wood Fiber Play Surfacing - Refresh (BASE BID - ADD ALT 5 TO P-SS1)		321817
P-SS1		Rubber Cushioned Safety Surface	3/L5.0	321816
P-SS2		Rubber Cushioned Safety Surface 2	3/L5.0	321816
$\langle F \rangle$	FURNISHING			
F-B1		Relocated Bench with Back	1/L5.1	129300
F-B2		Backless Bench	2/L5.1	129300
F-B3		Picnic Tables and Benches	3/L5.1	129300
F-BG		Basketball Goal and Hoop		116816
F-BL1		Bollard Light	1/L5.4	265200
F-BL2	0	Removable Bollard	2/L5.4	129300
F-BR		Bike Rib - Bicycle Rack	5/L5.4	129300
F-DF	<b>∞</b>	Drinking Fountain	6/L5.4	224713
F-F1	•	Pipe Rail fence	1/L5.3	323120
F-F2	0 • • • • • • • 0	8' New Chain Link Fence	2/L5.3	323113
F-F3	-0-0-0-	Chain Link Fence Renovation North	3/L5.3	323113
F-F4	-00-	Chain Link Fence Renovation East	4/L5.3	323113
F-PE1		Play Equipment - PlayBooster System	1,2/L5.5	116816
F-PE2		Play Equipment - Atlas Play Structure		116816
F-PE3		Play Equipment - Tire Swing (ADD ALT 1)		116816
F-PE4		Play Equipment - Spinami <b>(ADD ALT 2)</b>		116816
F-S1	-•-	Park Sign	1/L5.2	101430
F-S2	- <del>B</del> -	Community Kiosk and Interprative Sign Panels	2/L5.2	101430 129300
F-TR		Trash Receptacle	7/L5.4	129300
		Existing Trash Receptacle		
⟨AP⟩	ASPHALT PAIN	NTING		
AP-1		Asphalt Paint- Hopscotch	1/L5.6	321823
AP-2		Asphalt Paint- Four Square	2/L5.6	321823
AP-3		Asphalt Paint- Basketball Color 1	3/L5.6	321823
AP-4		Asphalt Paint- Basketball Color 2	4/L5.6	321823
EXIST	ING			
	(•)	Existing Tree to Remain		
	10	Existing Major Contour		
	9	Existing Minor Contour		
		Electrical Conduit		
		Abandoned Sewer Pipe		
	D W S	Exiting Utility Lines		

RUBBERIZED CUSHIONED SAFETY SURFACE - SUBSITUTE FOR WOOD FIBER PLAY SURFACE IN AREA (P-PM1) AND (P-PM3) ONLY.

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MATERIALS REFERENCE NOTES

1 See 4/L5.3 renovation to fence on east property line

2 See 3/L5.3 for renovation to fence on north property line.

(1) Bollard and (2) Bollard receptacles

4 See drawings A100, A200, A500 for Pavillion construction

Existing swingset to be re-painted to match Play Booster Poles, provide (4) new swings, see Play Equipment spec for details

6 Refresh existing play mulch, add to restore proper grade as needed. 7 Irrigation cabinet, design build. LA to confirm location in field.

8 Provide conduits under new asphalt paths for irrigation.

9 Existing curb to remain

10 Existing trashcan to remain



MARY JANE LEE PARK PHASE II

Palmer St Salem, MA 01970

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July 20, 2016


DRAWING TITLE:

PROJECT NUMBER: 1405.1

MATERIALS PLAN

1/16" =1'



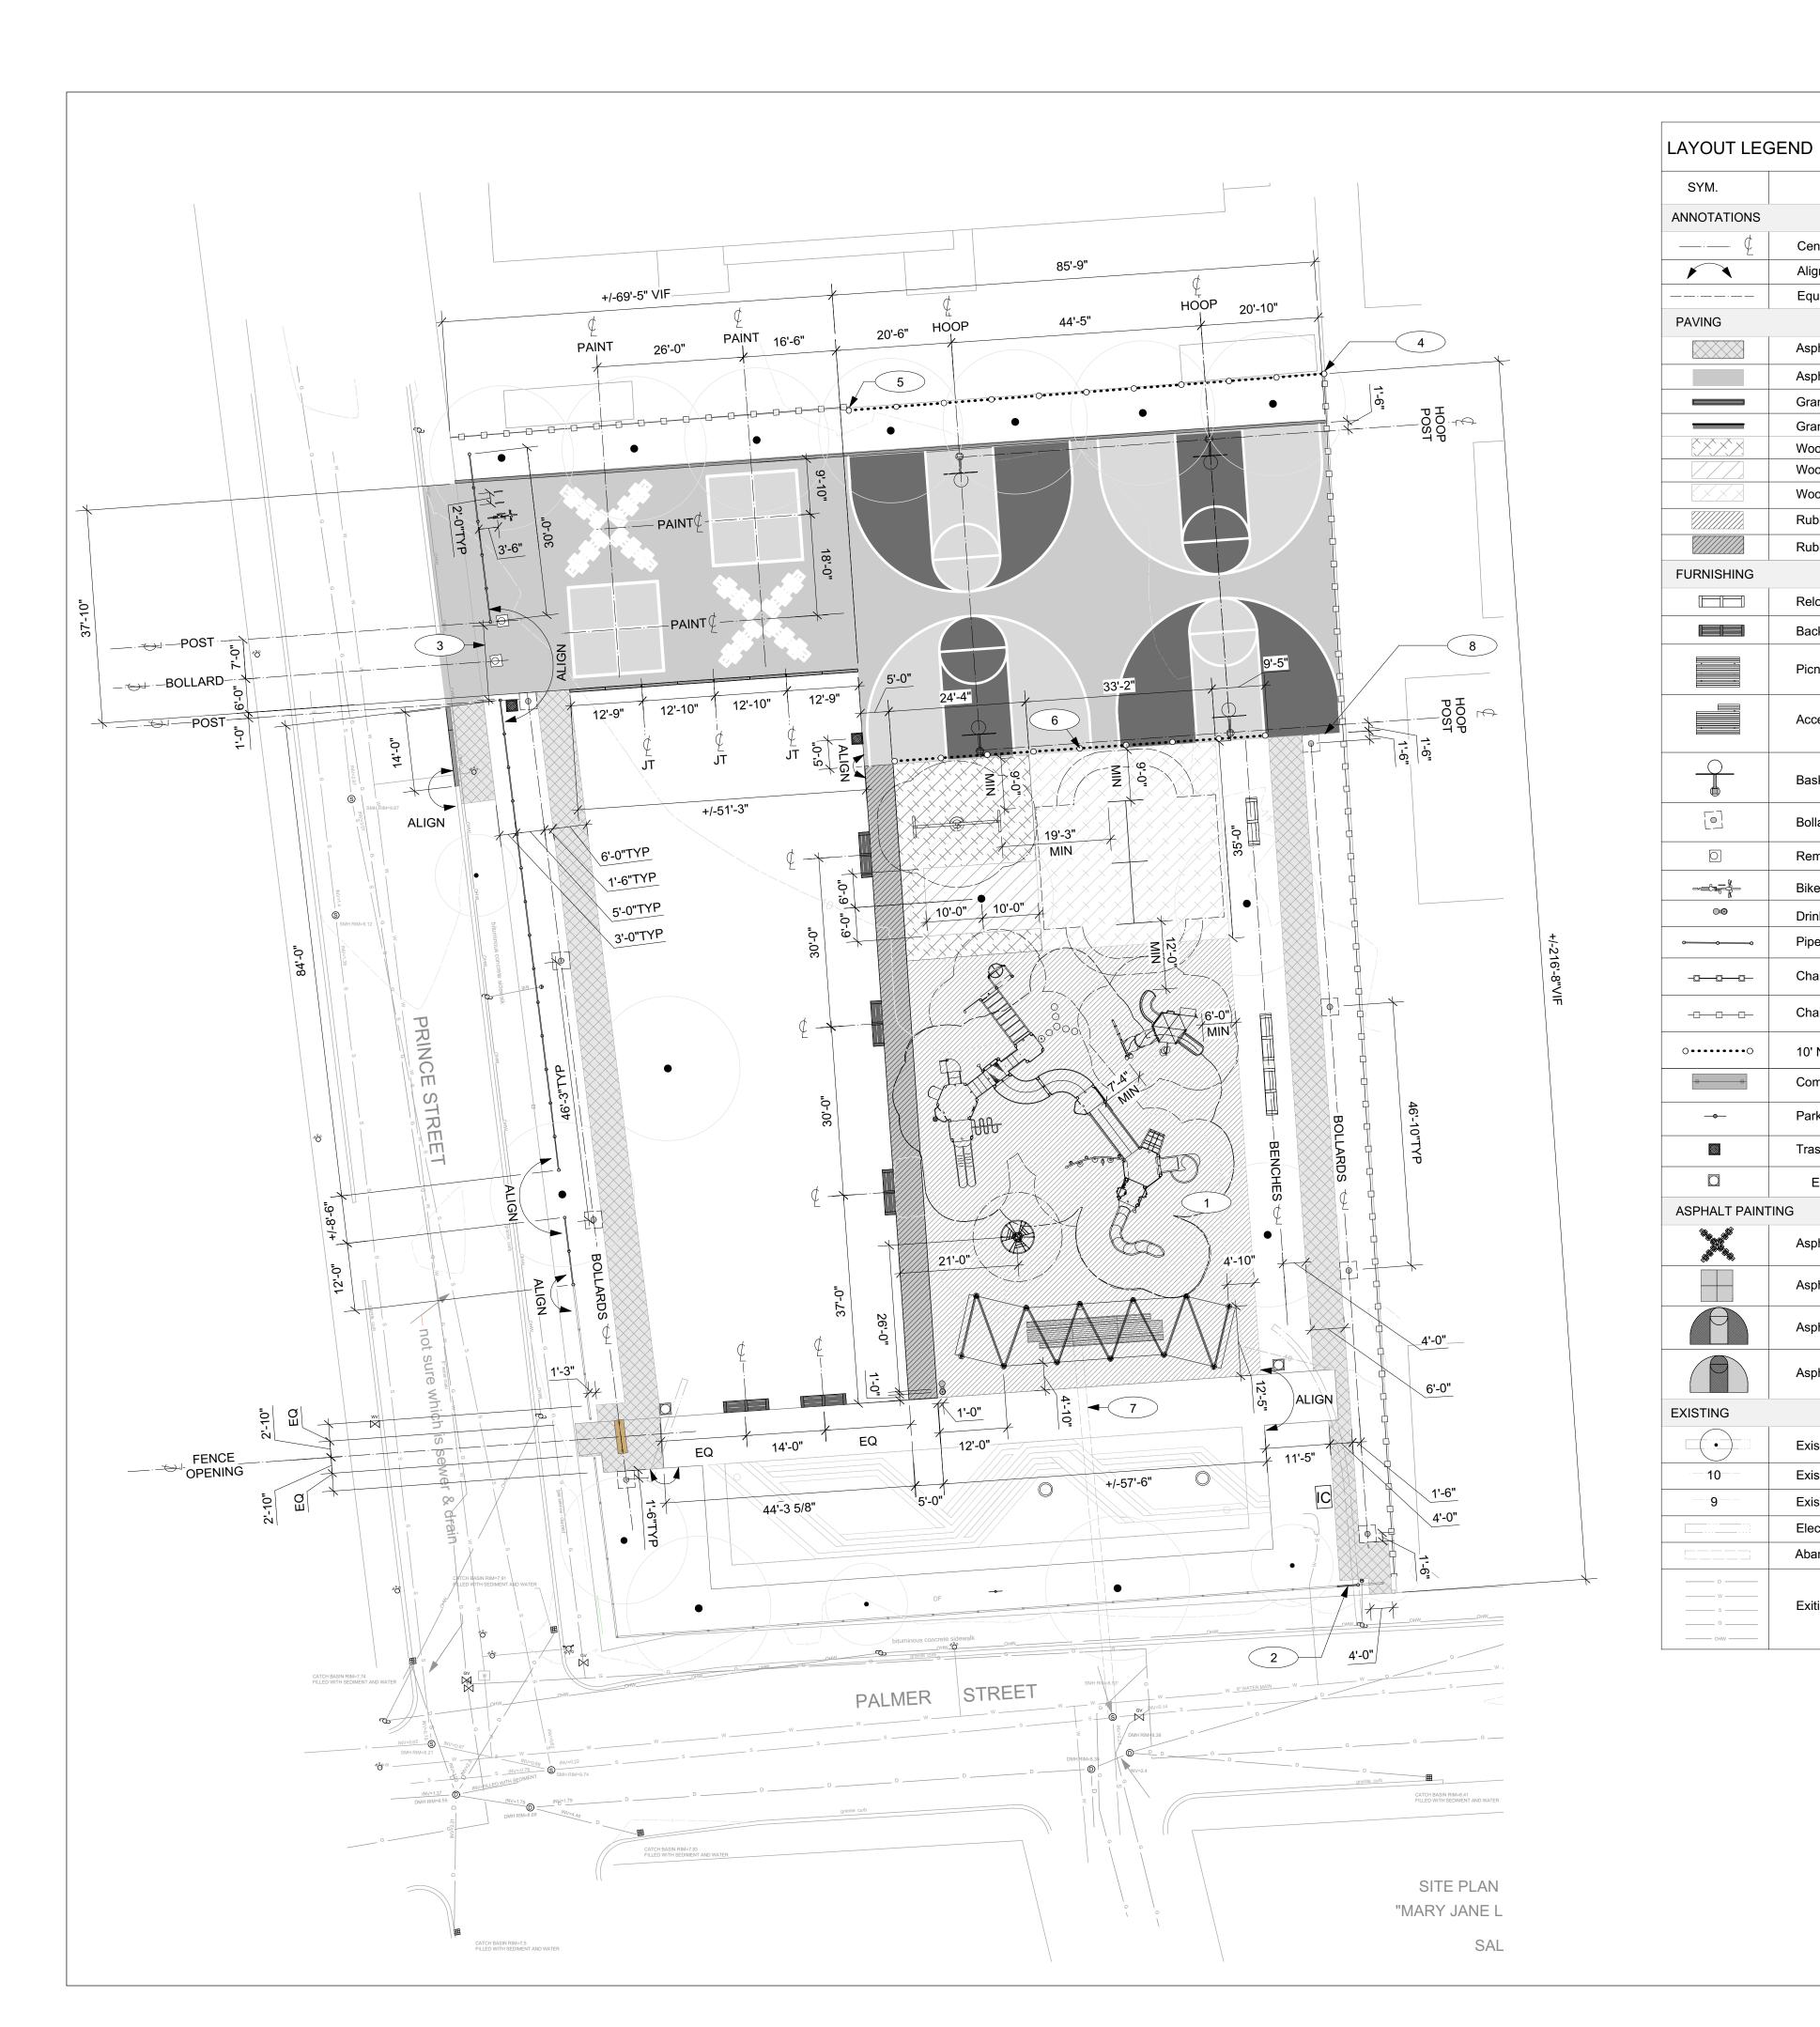

DESCRIPTION

Equipment Fall Zone -VIF

Asphalt Paving - Pedestrian

Asphalt Paving - Vehicular

Wood Fiber Play Surfacing

Rubberized Play Surface

Rubberized Play Surface 2

Relocated Bench with Back

Accessible Picnic Bench & Table

Backless Bench

Basketball Hoop

Removable Bollard

**Drinking Fountain** 

Pipe Rail fence

Bike Rib - Bicycle Rack

Chain Link Fence Renovation North

Chain Link Fence Renovation East

10' New Chain Link Fence

Existing Trash Receptacle

Asphalt Paint- Hopscotch

Asphalt Paint- Four Square

Asphalt Paint- Basketball Alt1

Asphalt Paint- Basketball Alt2

Existing Tree to Remain

**Existing Major Contour** 

**Existing Minor Contour** 

Abandoned Sewer Pipe

Exiting Utility Lines

**Electrical Conduit** 

Community Kiosk Sign

Park Sign

Trash receptacle

Bollard Light

Picnic Bench & Table

Wood Fiber Play Surfacing at Tree

Wood Fiber Play Surfacing - Refresh

Granite Curb - Raised

Granite Curb

Centerline

Align

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# **LAYOUT NOTES**

1. Do not scale drawings.

2. Contractor shall verify all existing conditions and layout dimensions in the field. Report any discrepancies to the Landscape Architect for design prior to commencing construction. 3. Stake or otherwise flag all design elements and features in the field. Obtain Landscape Architect's approval prior to commencing construction.

4. All dimensions from structure are from face of finish of exterior wall unless otherwise stated. 5. All angles are assumed to be 90 degrees unless otherwise stated. 6. See planting plans for location of trees and shrubs, planting beds and extent of sodding and

7. See architectural drawings for all building dimensions.

8. Dimensions at curbs of pavement edging are given from outside face of curb to outside face of curb unless otherwise stated. 9. Any changes proposed to dimensions shown on this drawing shall be approved by the Landscape Architect prior to construction.

# LAYOUT REFERENCE NOTES

No structures within manufacturer's defined fall zones for any play equipment.

Size length of rail to allow for 4' clear between existing wood post and new end post of pipe rail fence. Use existing rail and new posts.

Minimum 12' clear between northern bollard position and fence post/trash can.

(10) Equal panels of 10' high chain link fence to begin at finish of existing 8' fence, aligned with property line.

new 10' fence. VIF.

(8) Equal panels of 10' high chain link fence

No passable gap between rehabbed 6' fence and

centered between asphalt path and play surface path, located within asphalt paving behind basketball hoops, aligned with paving edge.

Approximate locatio of abandoned, capped sewer pipe. Approximatel depth 4-5' below grade. Contractor to field verify location and perform pavillion and associated work without damaging pipe. Notify LA if conflict with pavillion or discrepancy with location is found.

Existing edge of pavement



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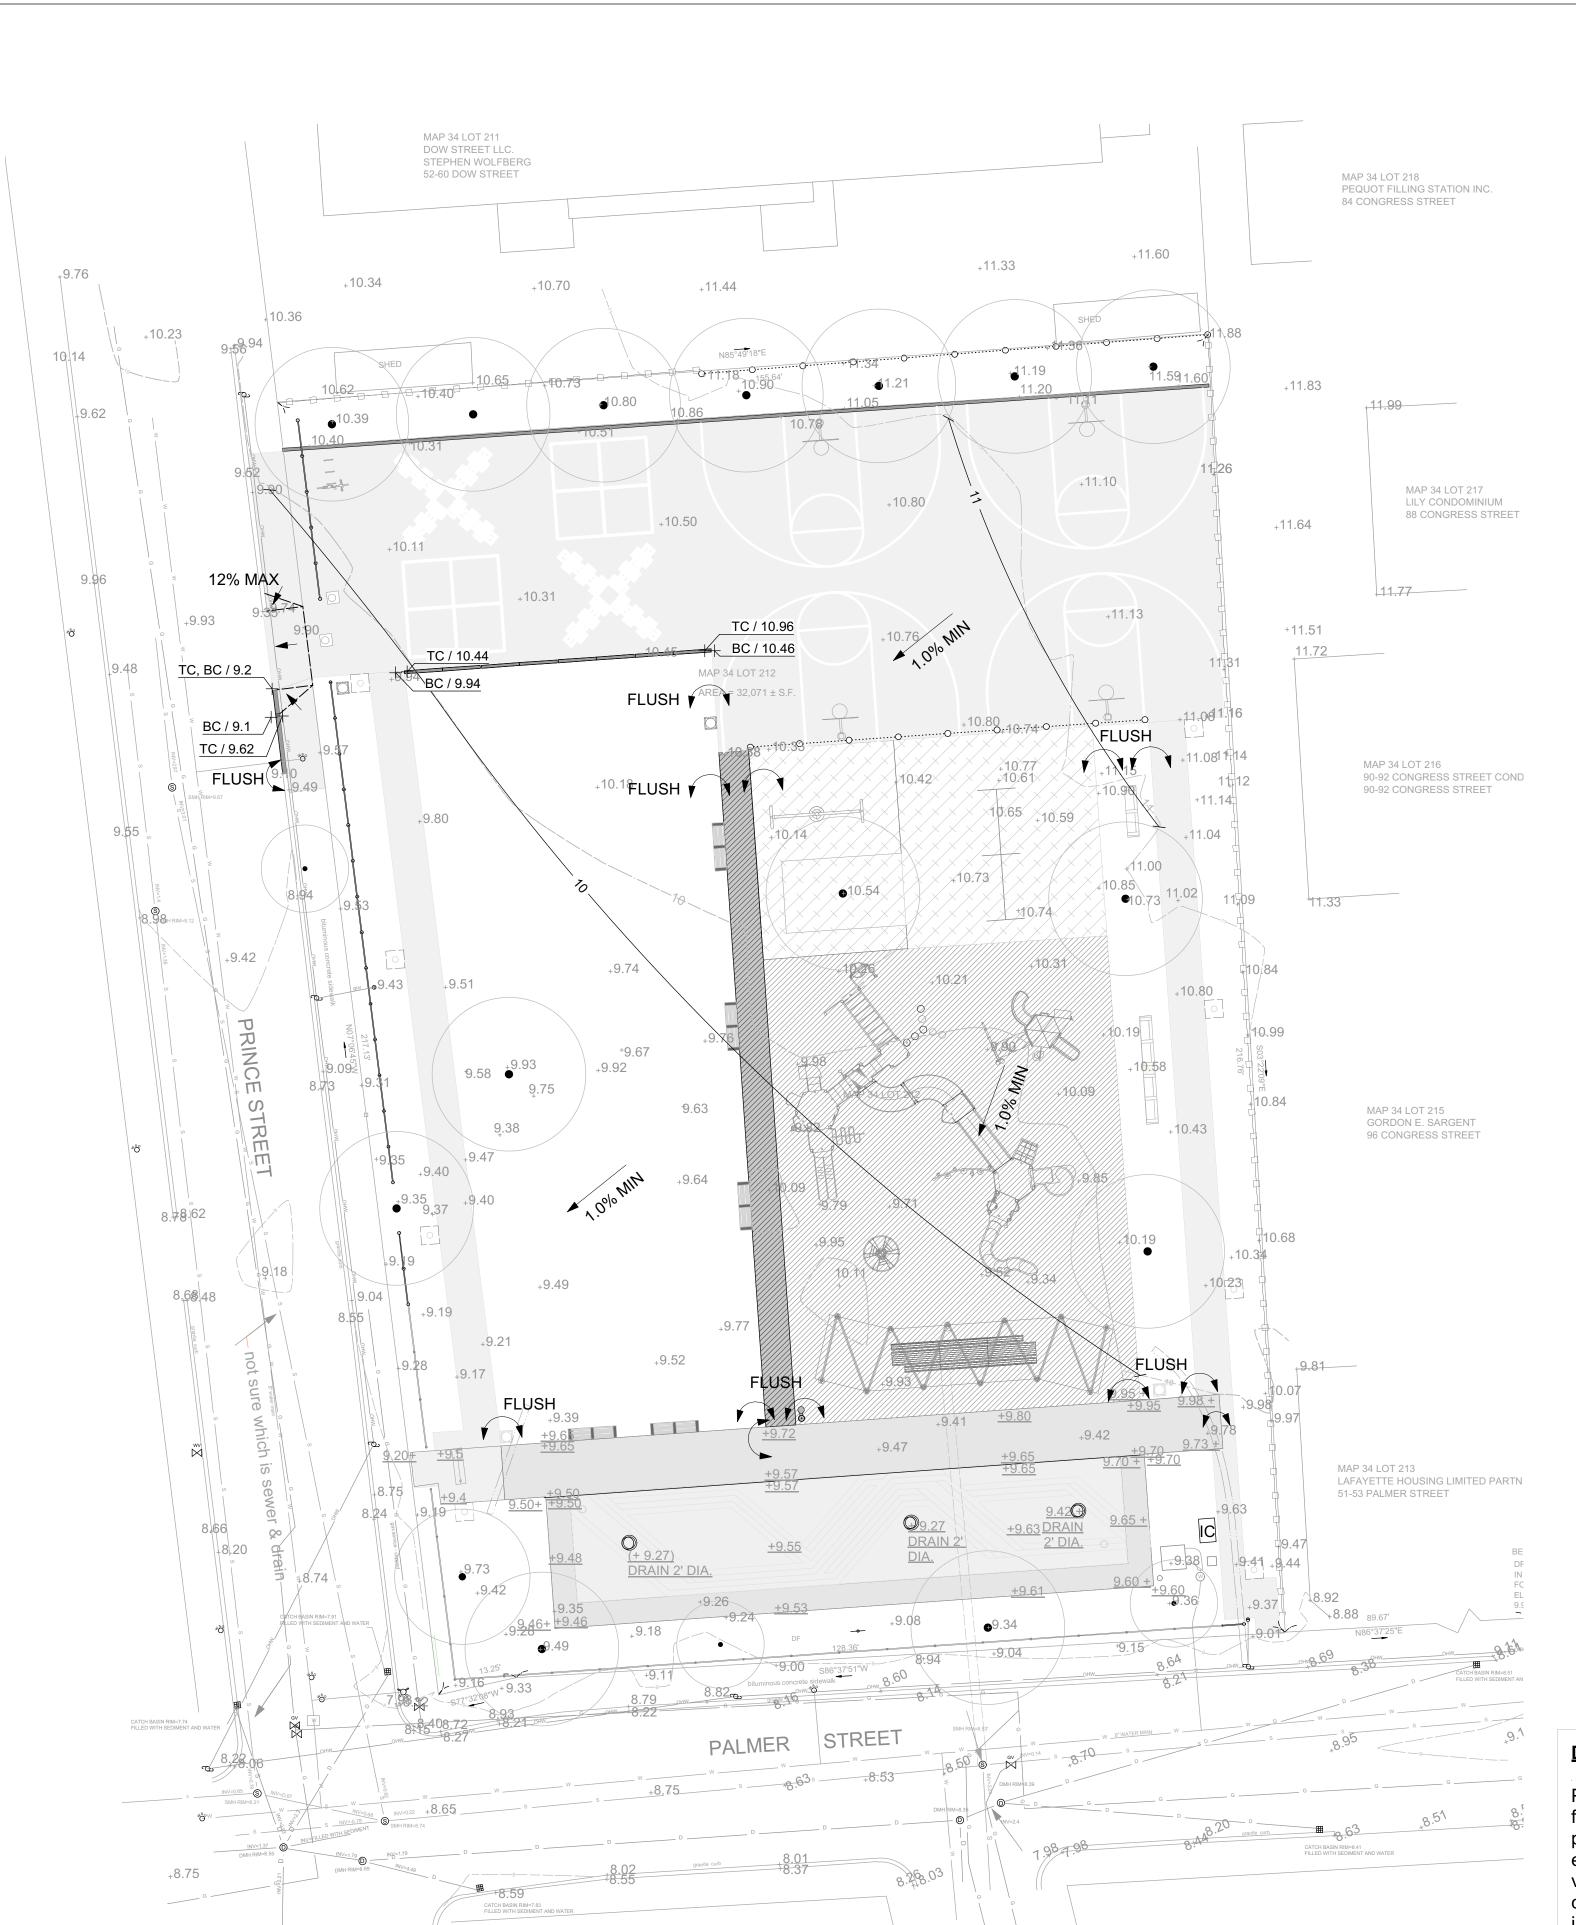


July 20, 2016 PROJECT NUMBER:

1/16" =1' 1405.1 DRAWING TITLE:

LAYOUT PLAN





SYM.	DESCRIPTION	
	Existing Major Contour	
9	Existing Minor Contour	
<u></u>	Proposed Major Contour	
<u>/</u> —11 <del>-/</del>		
	Proposed Minor Contour	
+10.42	Surveyed Spot Elevation	
+9.65	Phase I Designed Spot Elevation (AS BUILT - VIF)	
FLUSH 🗸 🐧	Surfaces to Align	
1.0% MIN <b>▼</b>	Minimum Pitch - No Low Points	
+ TC / 12.03	Top of Curb	
+ BC / 11.53	Bottom of Curb	
	Grade Break	
	Existing Drain	
—D	Exiting Utility Lines	
<del></del>		
AVING		
,	Asphalt Paving - Pedestrian	
	Asphalt Paving - Vehicular	
	Granite Curb - Raised Granite Curb	
	Play Mulch	
	Poured-in-place Playsurfacing	
	Poured-in-place Playsurfacing 2	
URNISHING		
ORNIOTIINO	Day about the Day I	
	Bench with Back	
	Backless Bench	
	Picnic Bench	
	Basketball Hoop	
	Bollard Light	
	Removable Bollard	
	Bike Rib - Bicycle Rack	
00	Drinking Fountain	
0	Pipe Rail fence	
-00-	Chain Link Fence Rehab	
OO	10' New Chain Link Fence	
	Community Kiosk Sign	
<b>-</b> ←	Park Sign	
<u> </u>	Trash receptacle	

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# **GRADING NOTES**

1. Contractor shall verify all existing grades in the field and report any discrepancies immediately to the landscape architect. 2. Stake proposed finish grade and cut/fills of existing grade in the field. Obtain Landscape Architect's approval prior to commencing construction.

3. Slope away from all buildings. 4. Provide vertical curves or roundings at abrupt changes in grade unless otherwise noted. Blend new earthwork smoothly into existing grades.

5. Maintain existing grades at existing plant material to remain 6. Grade surfaces to assure positive drainage from all structures and to prevent ponding of surface

7. All fill material is subject to approval by Landscape Architect. 8. Pitch evenly between spot grades. All paved areas must pitch to drain at a minimum 1% slope.


Any discrepancies not allowing this to occur shall be reported to the Landscape Architect prior to continuing work. 9. Once grading operations are completed, all disturbed areas within or outside of the limits of work shall be stabilized by fine grading and seeding, sod or mulching as indicated on plan and directed by

the Landscape Architect. 10. All erosion control measures are to be constructed to meet field conditions at the time of construction and prior to any grading or disturbance of existing material on balance of site.

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DRAWING TITLE:


PROJECT NUMBER: 1/16" =1' 1405.1

**GRADING PLAN** 

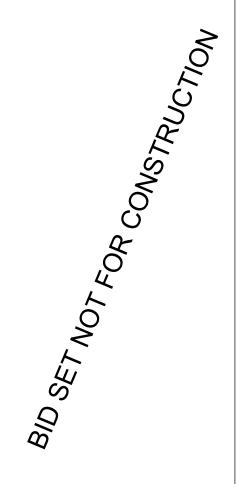



Play surfacing, walks, and lawn areas to be flush with existing splash pad and original parking lot asphalt spot elevations. Pitch evenly between. No low points. Contracter to verify grades in field and notify LA of any conflicts between existing grades and design

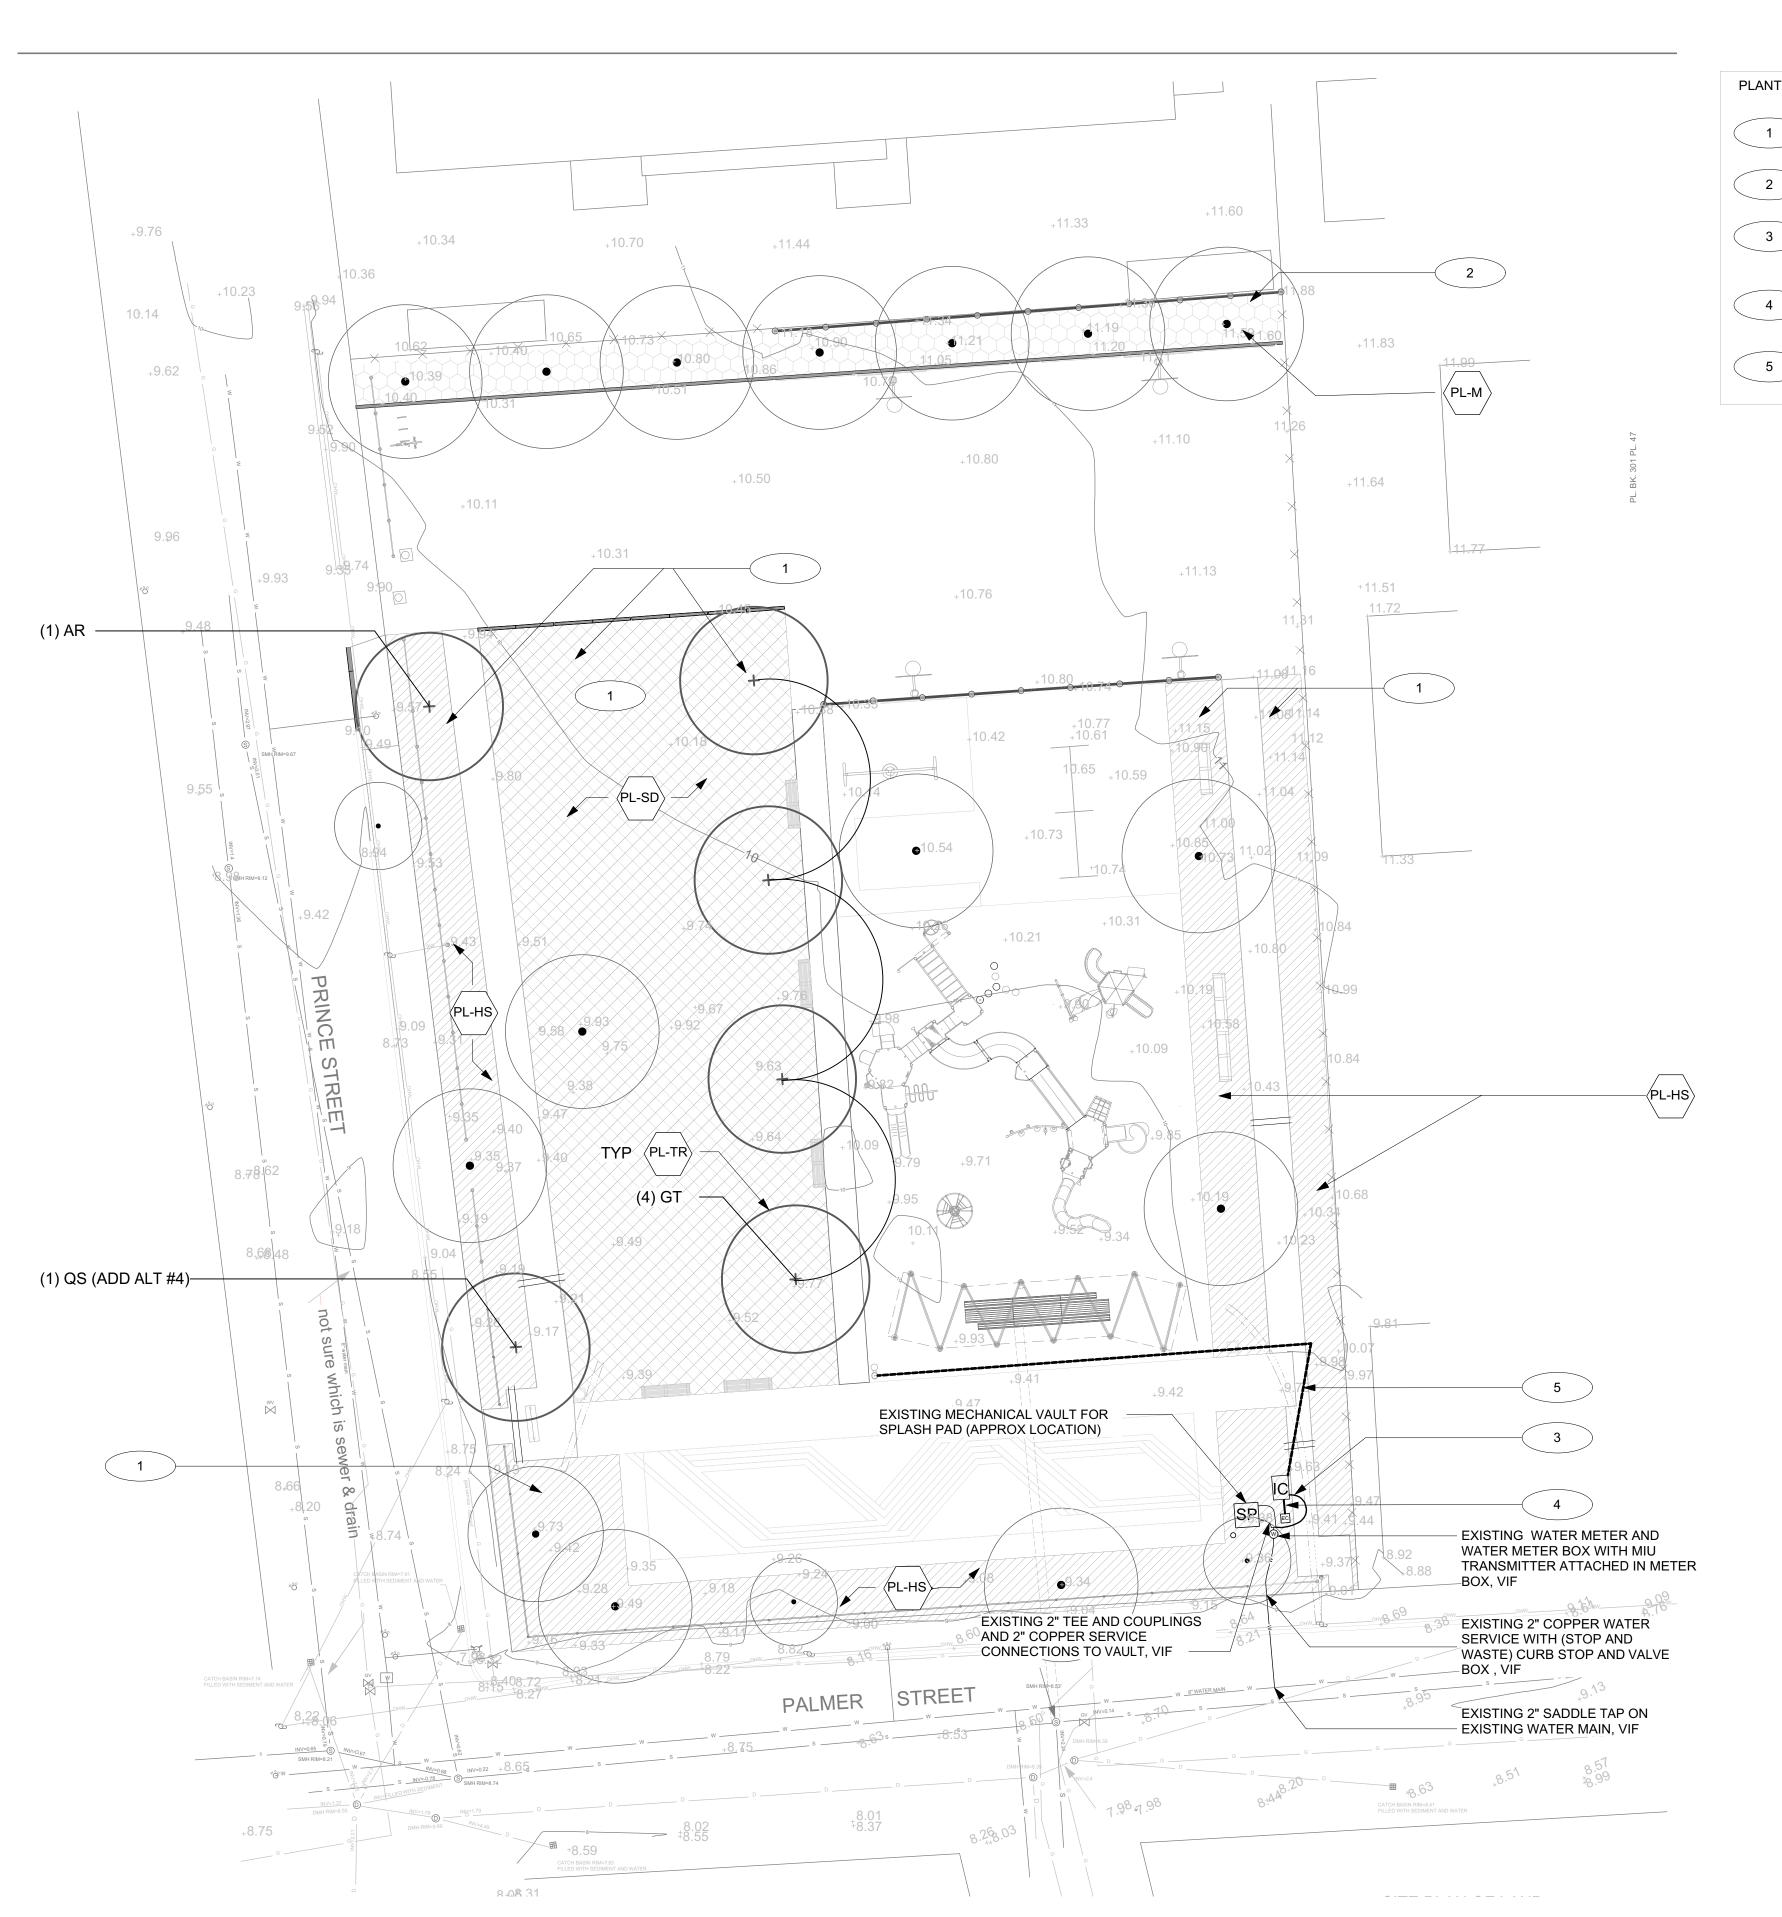

# PLANTING REFERENCE NOTES

Provide sprinkler heads for all lawn and new trees.

1 Tovide sprinker ricade for all lawit and new in

No irrigation in northern tree bed.

Irrigation system shall branch off from existing water source after existing water meter.

Hard wire irrigation timer and clock to existing electrical service within existing electrical cabinet.

Water line for drinking fountain

# **GENERAL NOTES**

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# **PLANTING NOTES**

The Contractor shall supply all plant material in quantities sufficient to complete the planting shown on all drawings.
 Contractor shall verify all existing conditions in the field. Report any discrepancies to the

Landscape Architect for design prior to commencing planting.

3. All plant material shall conform to the guidelines established by "The American Standard for Nursery Stock" published by the American Nursery and Landscape Association, latest edition.

4. All plants shall be balled and burlap unless otherwise noted on the plant list.5. All plants shall be approved by Landscape Architect prior to their installation at the site.6. Contractor shall stake all plant locations in the field. Obtain approval of Landscape Architect

before starting plant installations.
7. Plants to be transplanted shall be flagged and exact planting locations staked in the field.

# 7. Plants to be transplanted shall be flagged and exact planting locations staked in the field.8. All areas disturbed by construction activities are to be fine graded and seeded or sod, see plan.

# **IRRIGATION NOTES**

Site contractor to provide and install all sleeving for all irrigation work. Irrigation contractor shall provide all piping, valves and valve boxes, and quick couplers for installation of all irrigation work.
 An As-Built plan shall be produced by the contractor after final installation.

Installation methods shall comply with all manufacturers, state and local code.
 Contractor shall review and coordinate All pipe and valve locations with Landscape Architect for

approval prior to installation
5. Quick coupling valves shall be installed on one-inch PVC swing joints with brass inserts and

stabilizers.

6. Contractor shall test dynamic pressure before starting work, report any deviation from pressure

required to Landscape Architect before continuing.

7. Coordinate location of all existing and future utilities on site and contact proper authorities and

Coordinate location of all existing and future utilities on site and contact proper authorities and utility companies before start of work.

8. Install automatic flush ports at lowest point of PVC exhaust header.

9. Install air vacuum/relief valves at high point of PVC piping.

10. Contractor to submit shop drawings to the Landscape Architect for approval prior to ordering material and beginning work.

11. Any and all material substitutions which vary from the specified products must be submitted to Landscape Architect for approval as part of the submittal process.12. Contractor to care for any plantings in and around irrigation installation opera tions. Any

damage to root zones or limbs of any plantings and existing trees may result in replacement of plant material by the contractor.

# PLANTING LEGEND

KEY NOTE	SYM.	DESCRIPTION	DETAIL/ SHEET	SPEC. SECTION(S)
PL-SD		Sod	2/L5.7	329200
PL-HS		Hydroseeded Lawn (Base Bid - ADD ALT 3 TO PL-SD)	1/L5.7	329200
PL-M	***************************************	Mulch		329300
PL-TR	$\overline{\bullet}$	Tree	3/L5.7	329300
	•	Existing Tree to Remain		
—	<del>10</del>	Existing Major Contour		
_	<del>9</del>	Existing Minor Contour		
	=======================================	Electrical Conduit		
	——D———————————————————————————————————	Exiting Utility Lines		

PLANT SCHEDULE					
QTY	SYM	BOTANICAL NAME	COMMON NAME	SIZE	COMMENTS
TREES					
4	GT	Gleditsia triacanthos inermis	Honey Locust	5" CAL.	B & B
1	AR	Acer rubrum	Red maple	5" CAL.	B & B
1	QS	Quercus palustris	Pin Oak	4" CAL.	B & B Add Alt. 4


ADD AL	TERNATES
ADD ALT#	DESCRIPTION
3	Sod - substituted in all areas shown in base bid as hydroseeded lawn
4	(1) Quercus palustris- Pin Oak 4" CAL. B & B



MARY JANE LEE PARK PHASE II

Palmer St Salem, MA 01970

BID SET

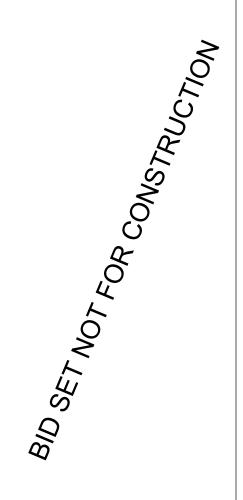

No. Date Revision

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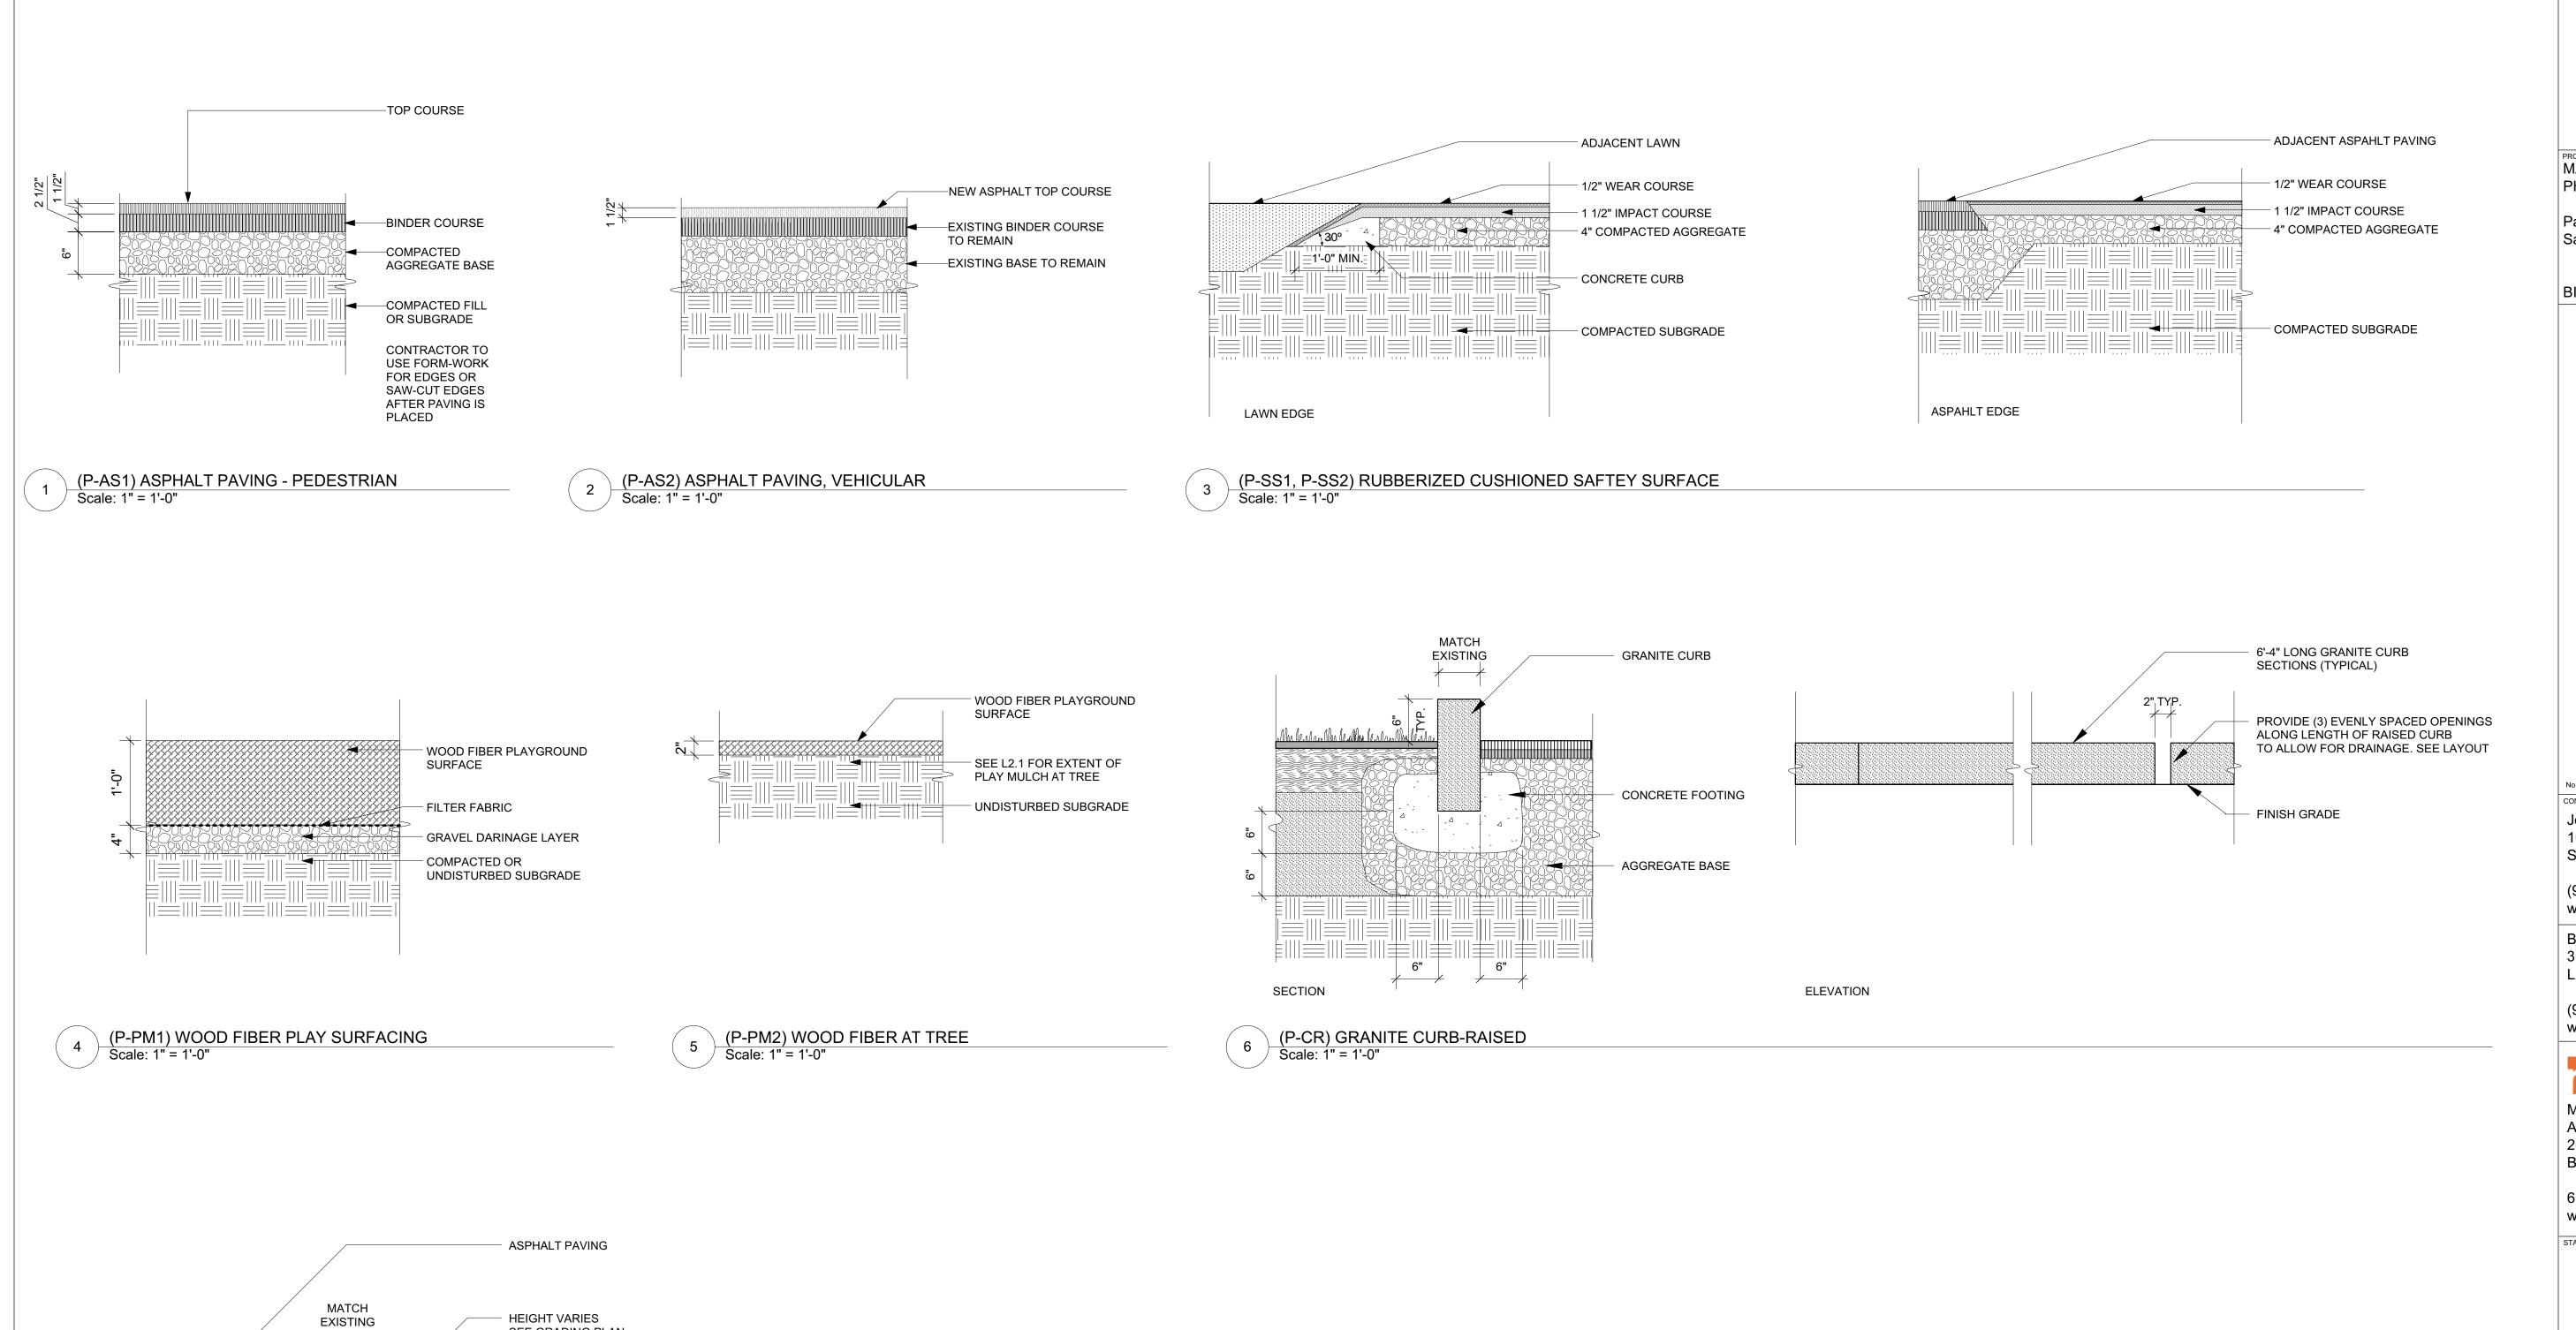
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July 20, 2016

Planting Plan

L4.0



HEIGHT VARIES
SEE GRADING PLAN

- EXISTING ASPHALT STREET TO BE REPAIRED AS NEEDED

RE-SET GRANITE CURB SALVAGED FROM SITE.


ANY NEW CURB TO MATCH EXISTINGIN IN

CONCRETE FOOTING

DIMENSIONS AND FINISH

FLUSH

7 (P-GC) GRANITE CURB
Scale: 1" = 1'-0"

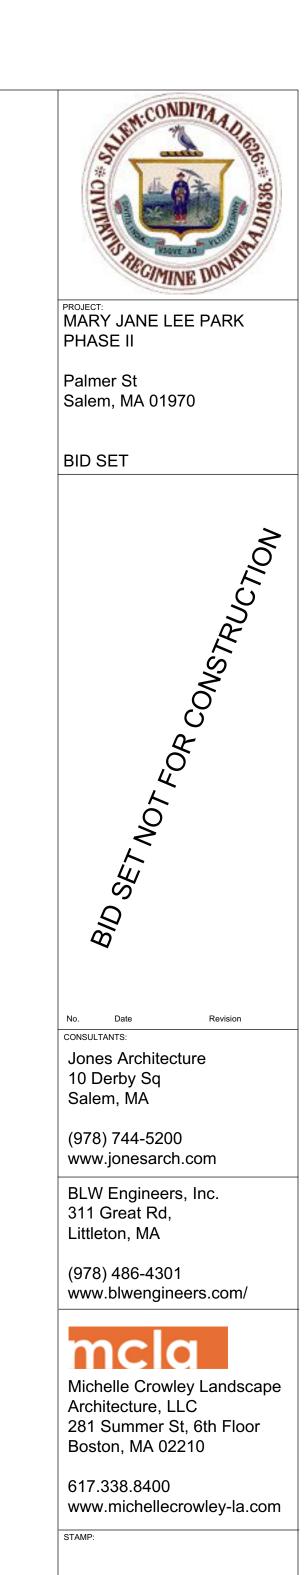


Paving Details

As Noted

July 20, 2016

1405.1

DRAWING TITLE:

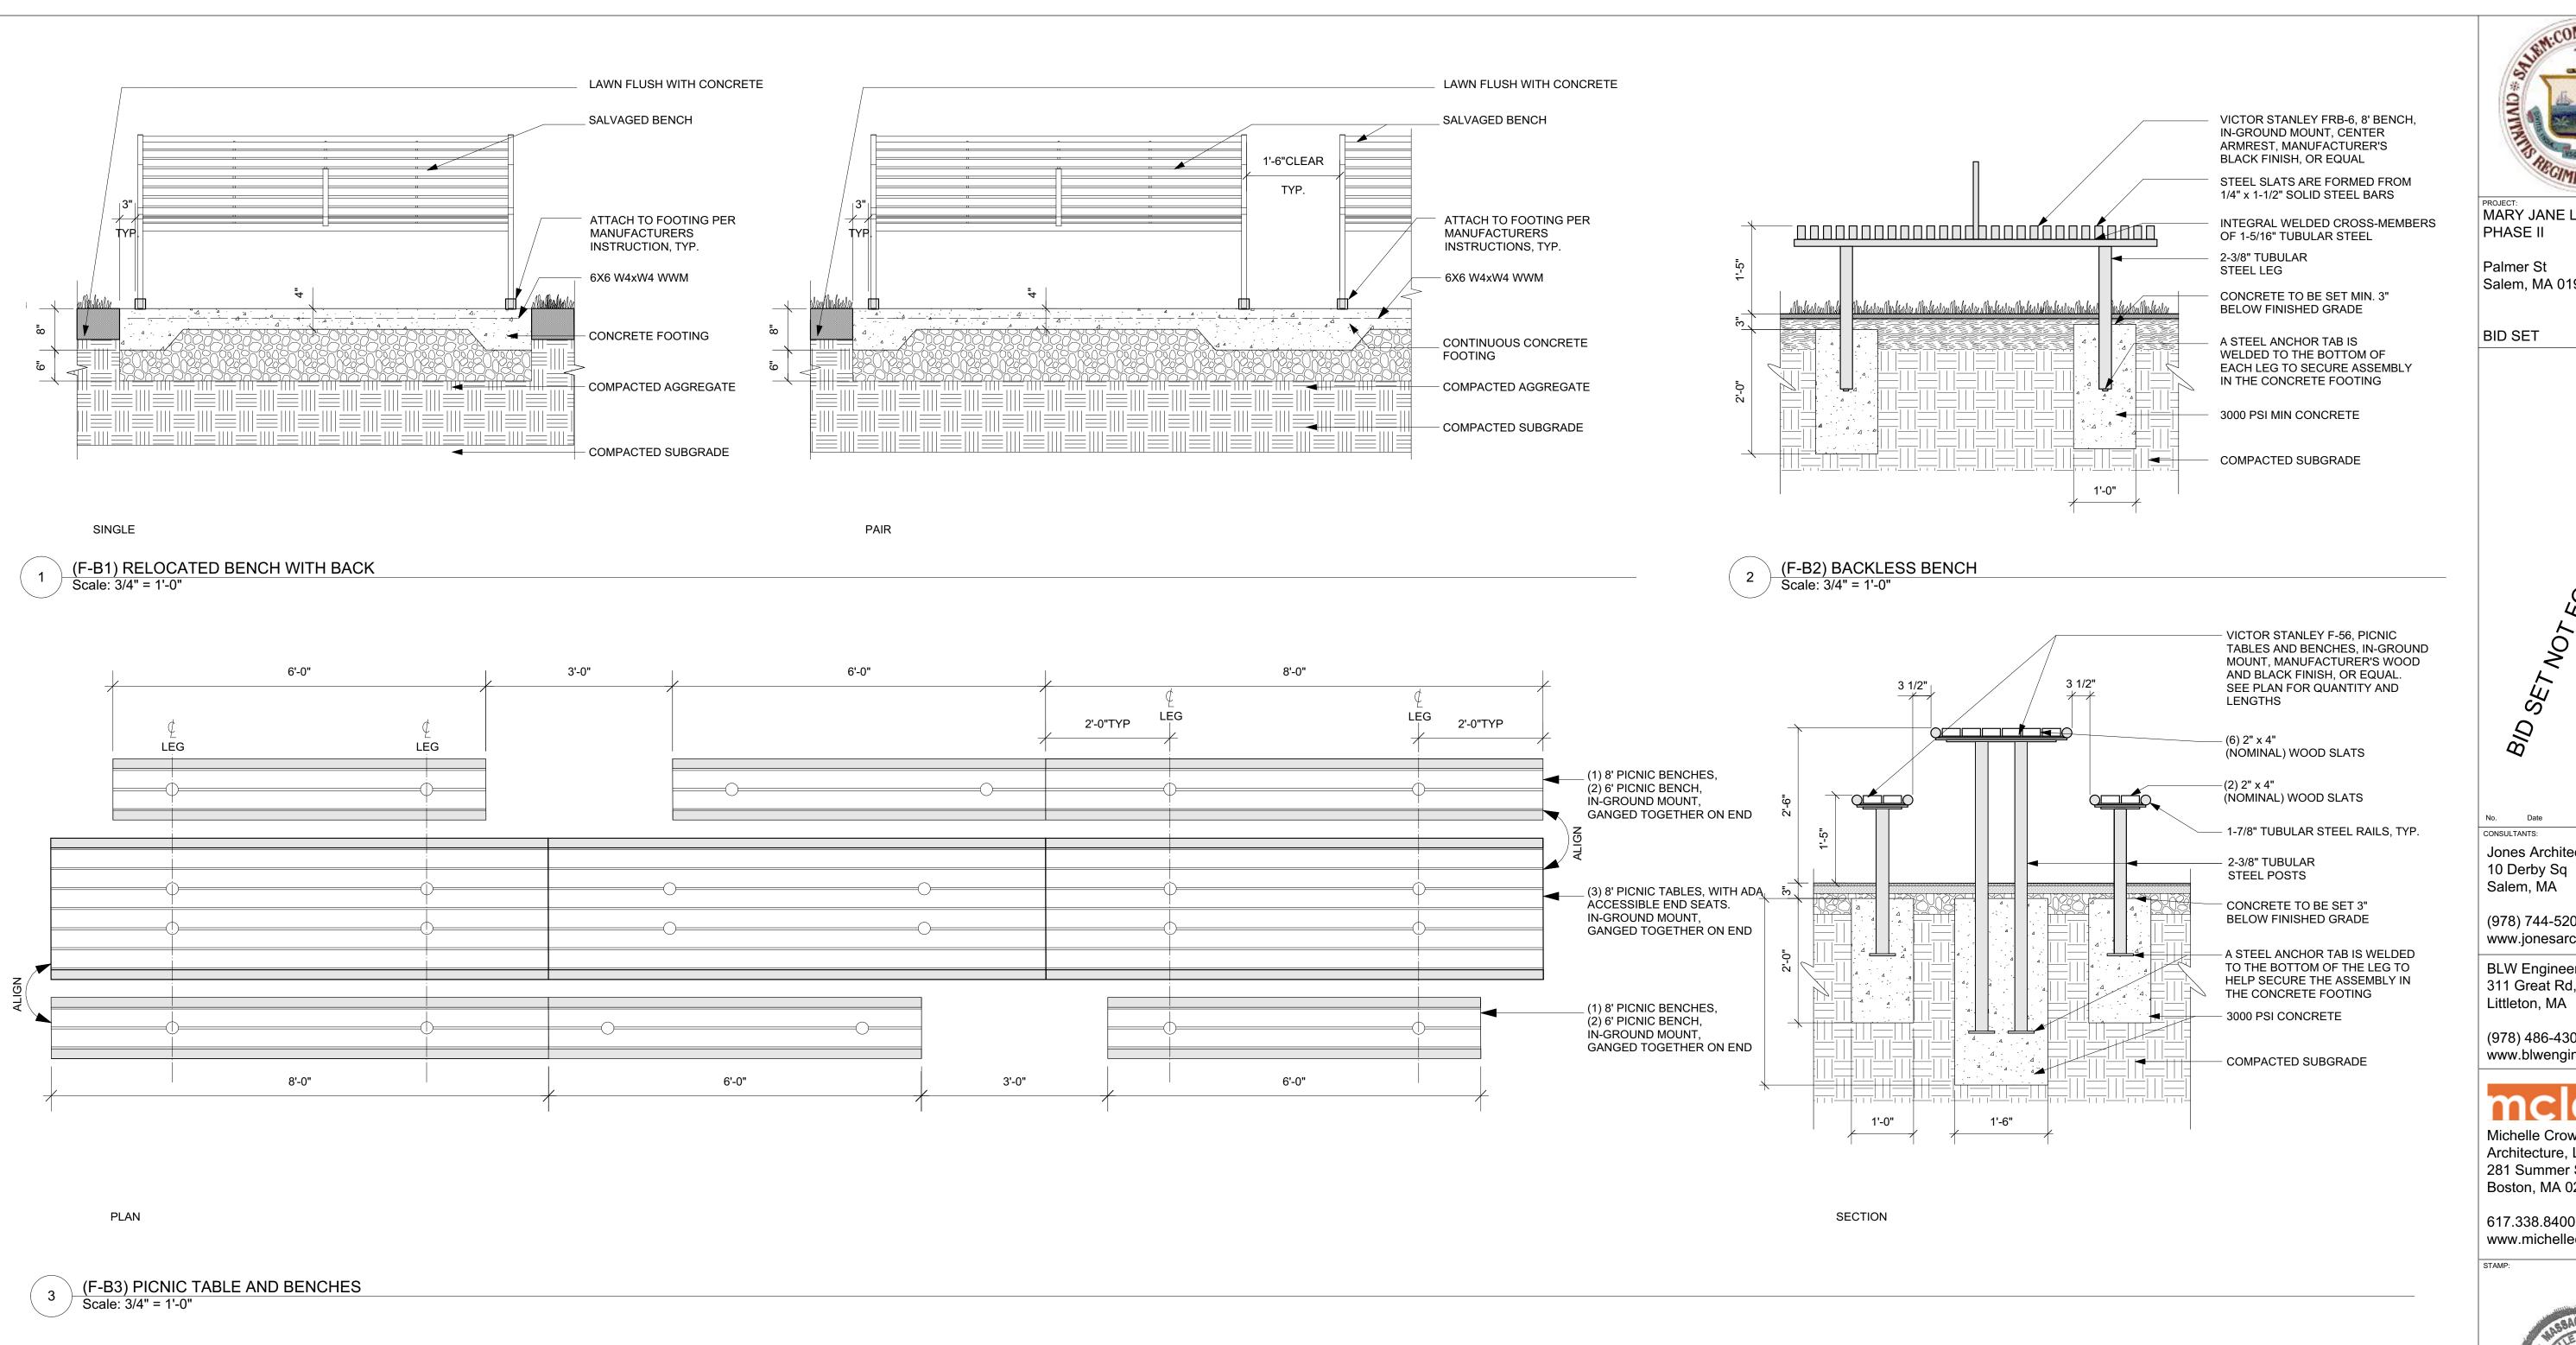



MARY JANE LEE PARK PHASE II

Palmer St Salem, MA 01970

BID SET

TFOR CONSTRUCTION

CONSULTANTS: Jones Architecture

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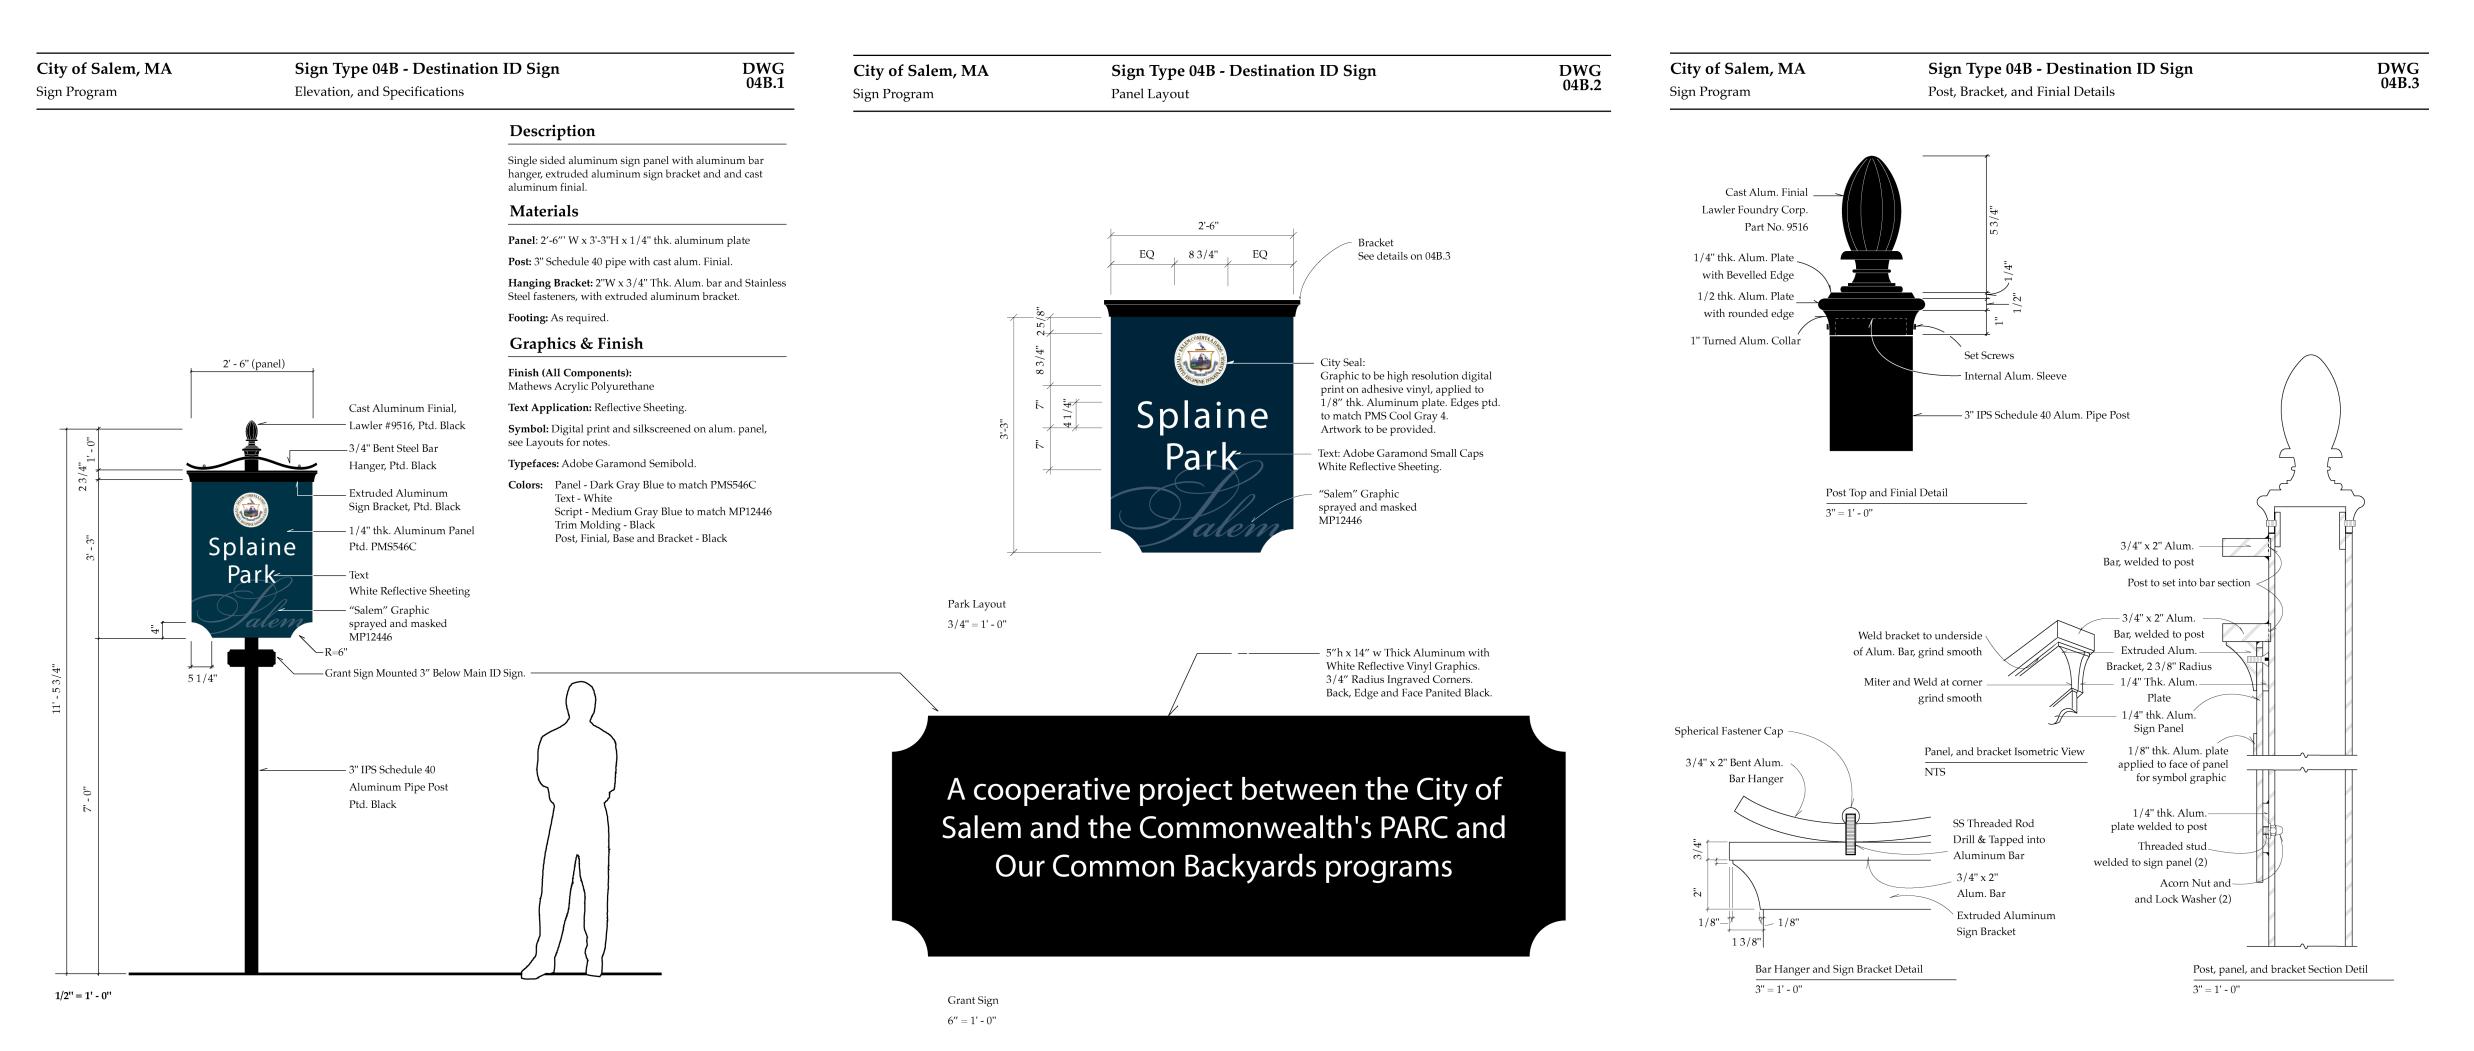
617.338.8400 www.michellecrowley-la.com




July 20, 2016

1405.1 As Noted

> Furnishing Details - Benches



1 (F-S1) PARK SIGN AS NOTED

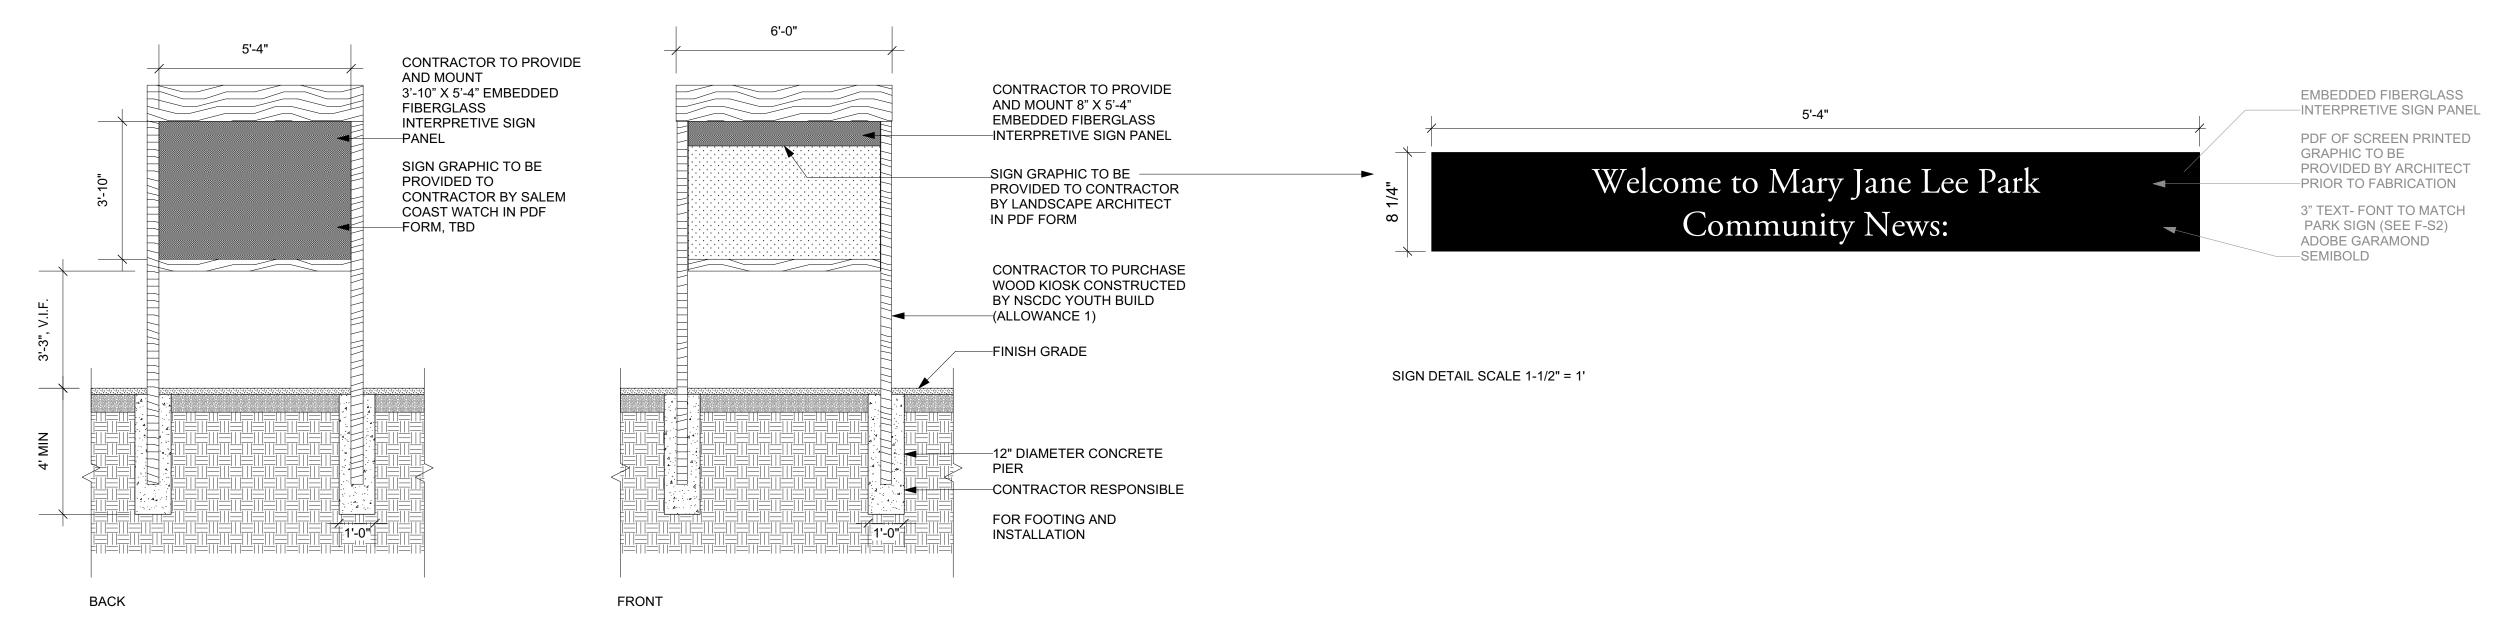

SCALE 3/8" = 1'


(F-S2) COMMUNITY KIOSK AND INTERPRETIVE SIGN PANELS AS NOTED



MARY JANE LEE PARK PHASE II

Palmer St Salem, MA 01970

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DATE:

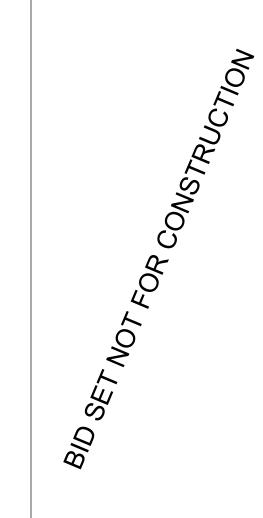
July 20, 2016


PROJECT NUMBER: SCALE:

1405.1 As Noted


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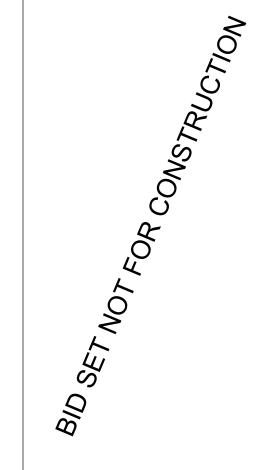
Furnishing Details - Signs



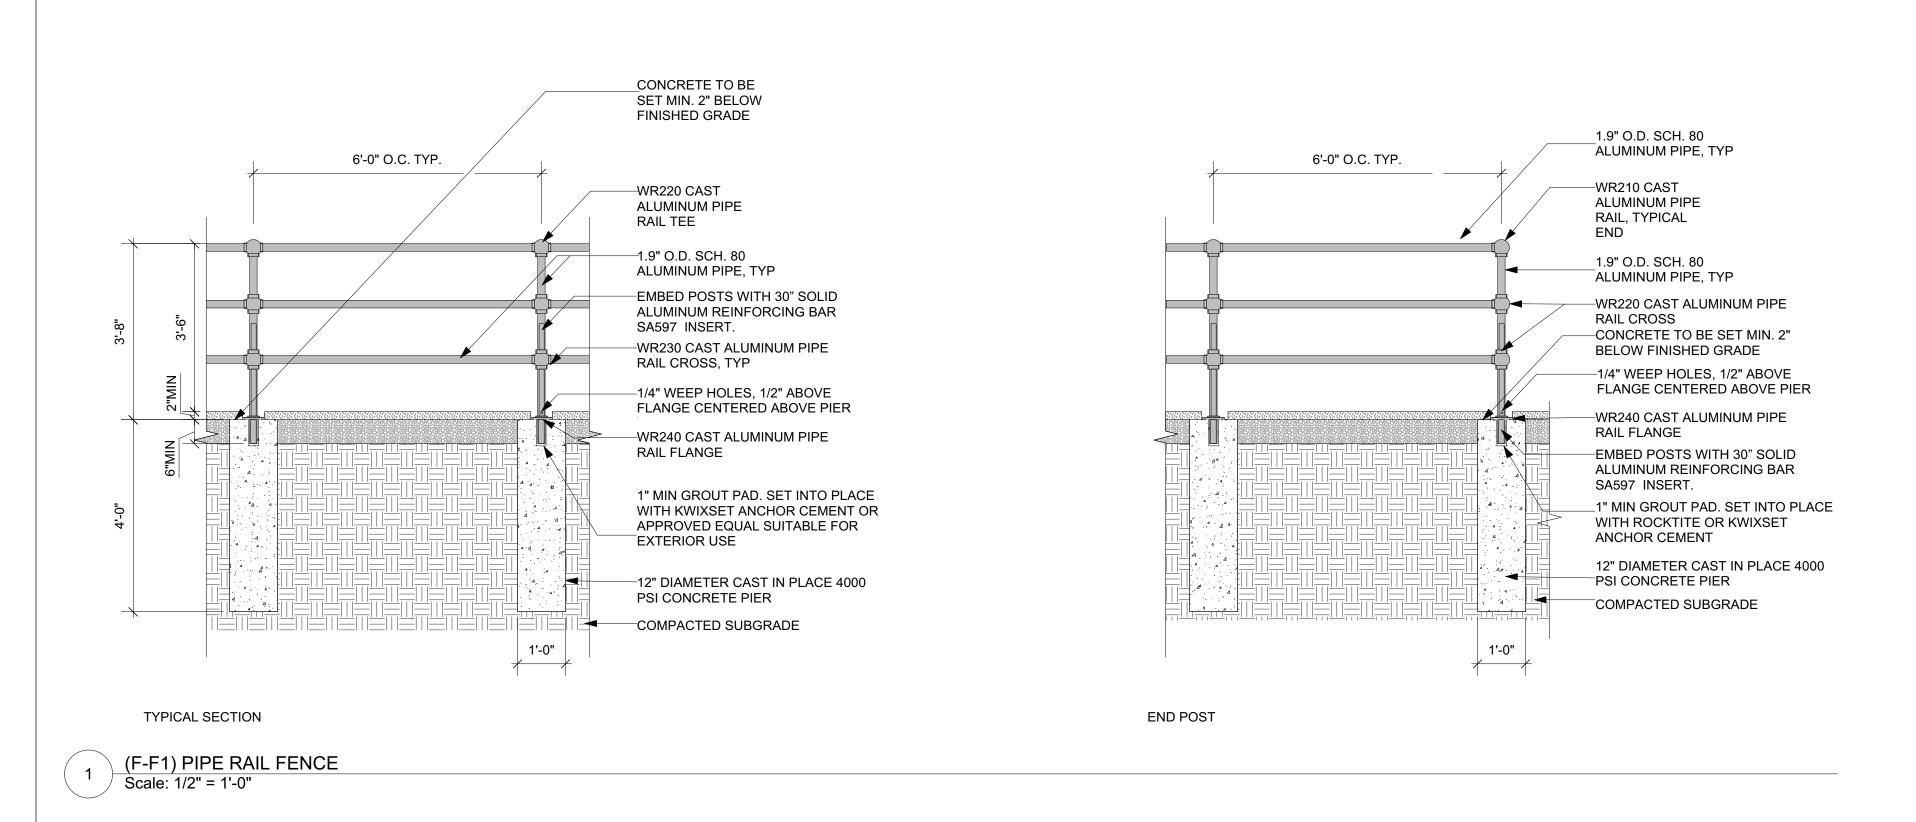

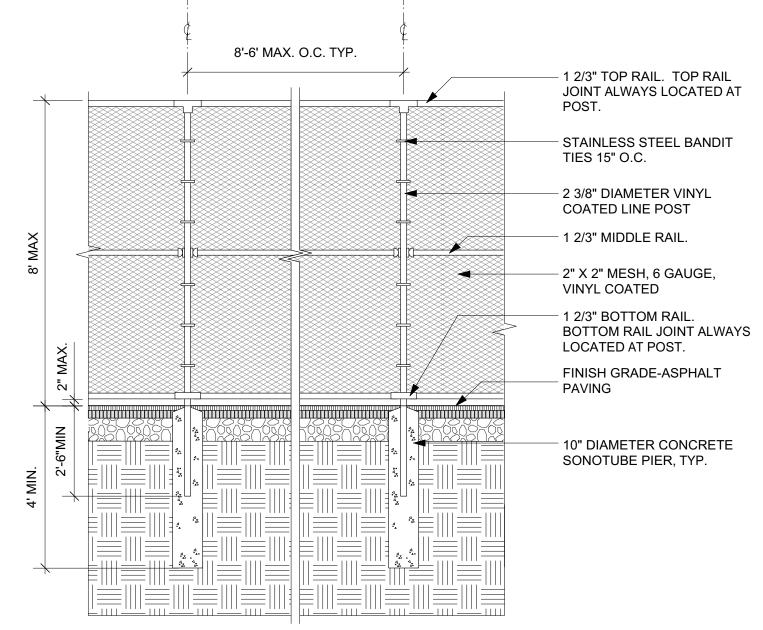(F-F2) 8' NEW CHAIN LINK FENCE Scale: 3/8" = 1'-0"



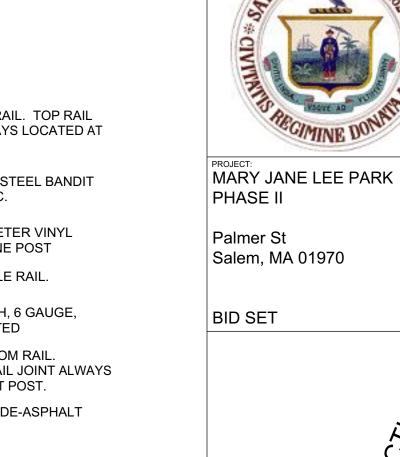

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# Michelle Crowley Landsc

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STAMP:




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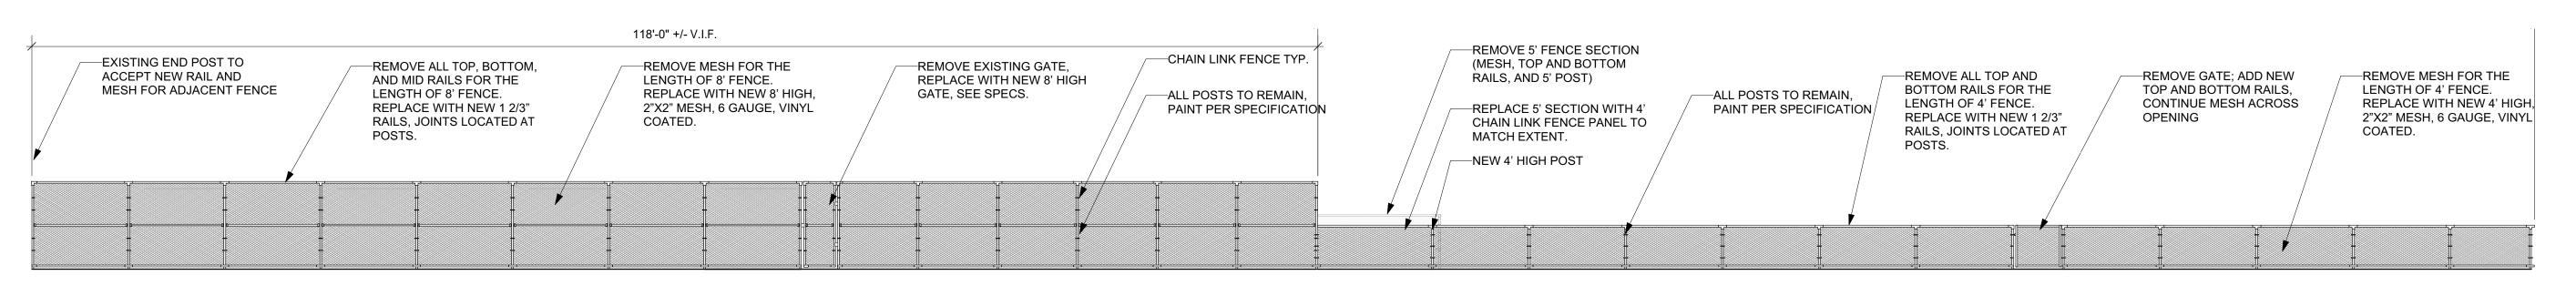
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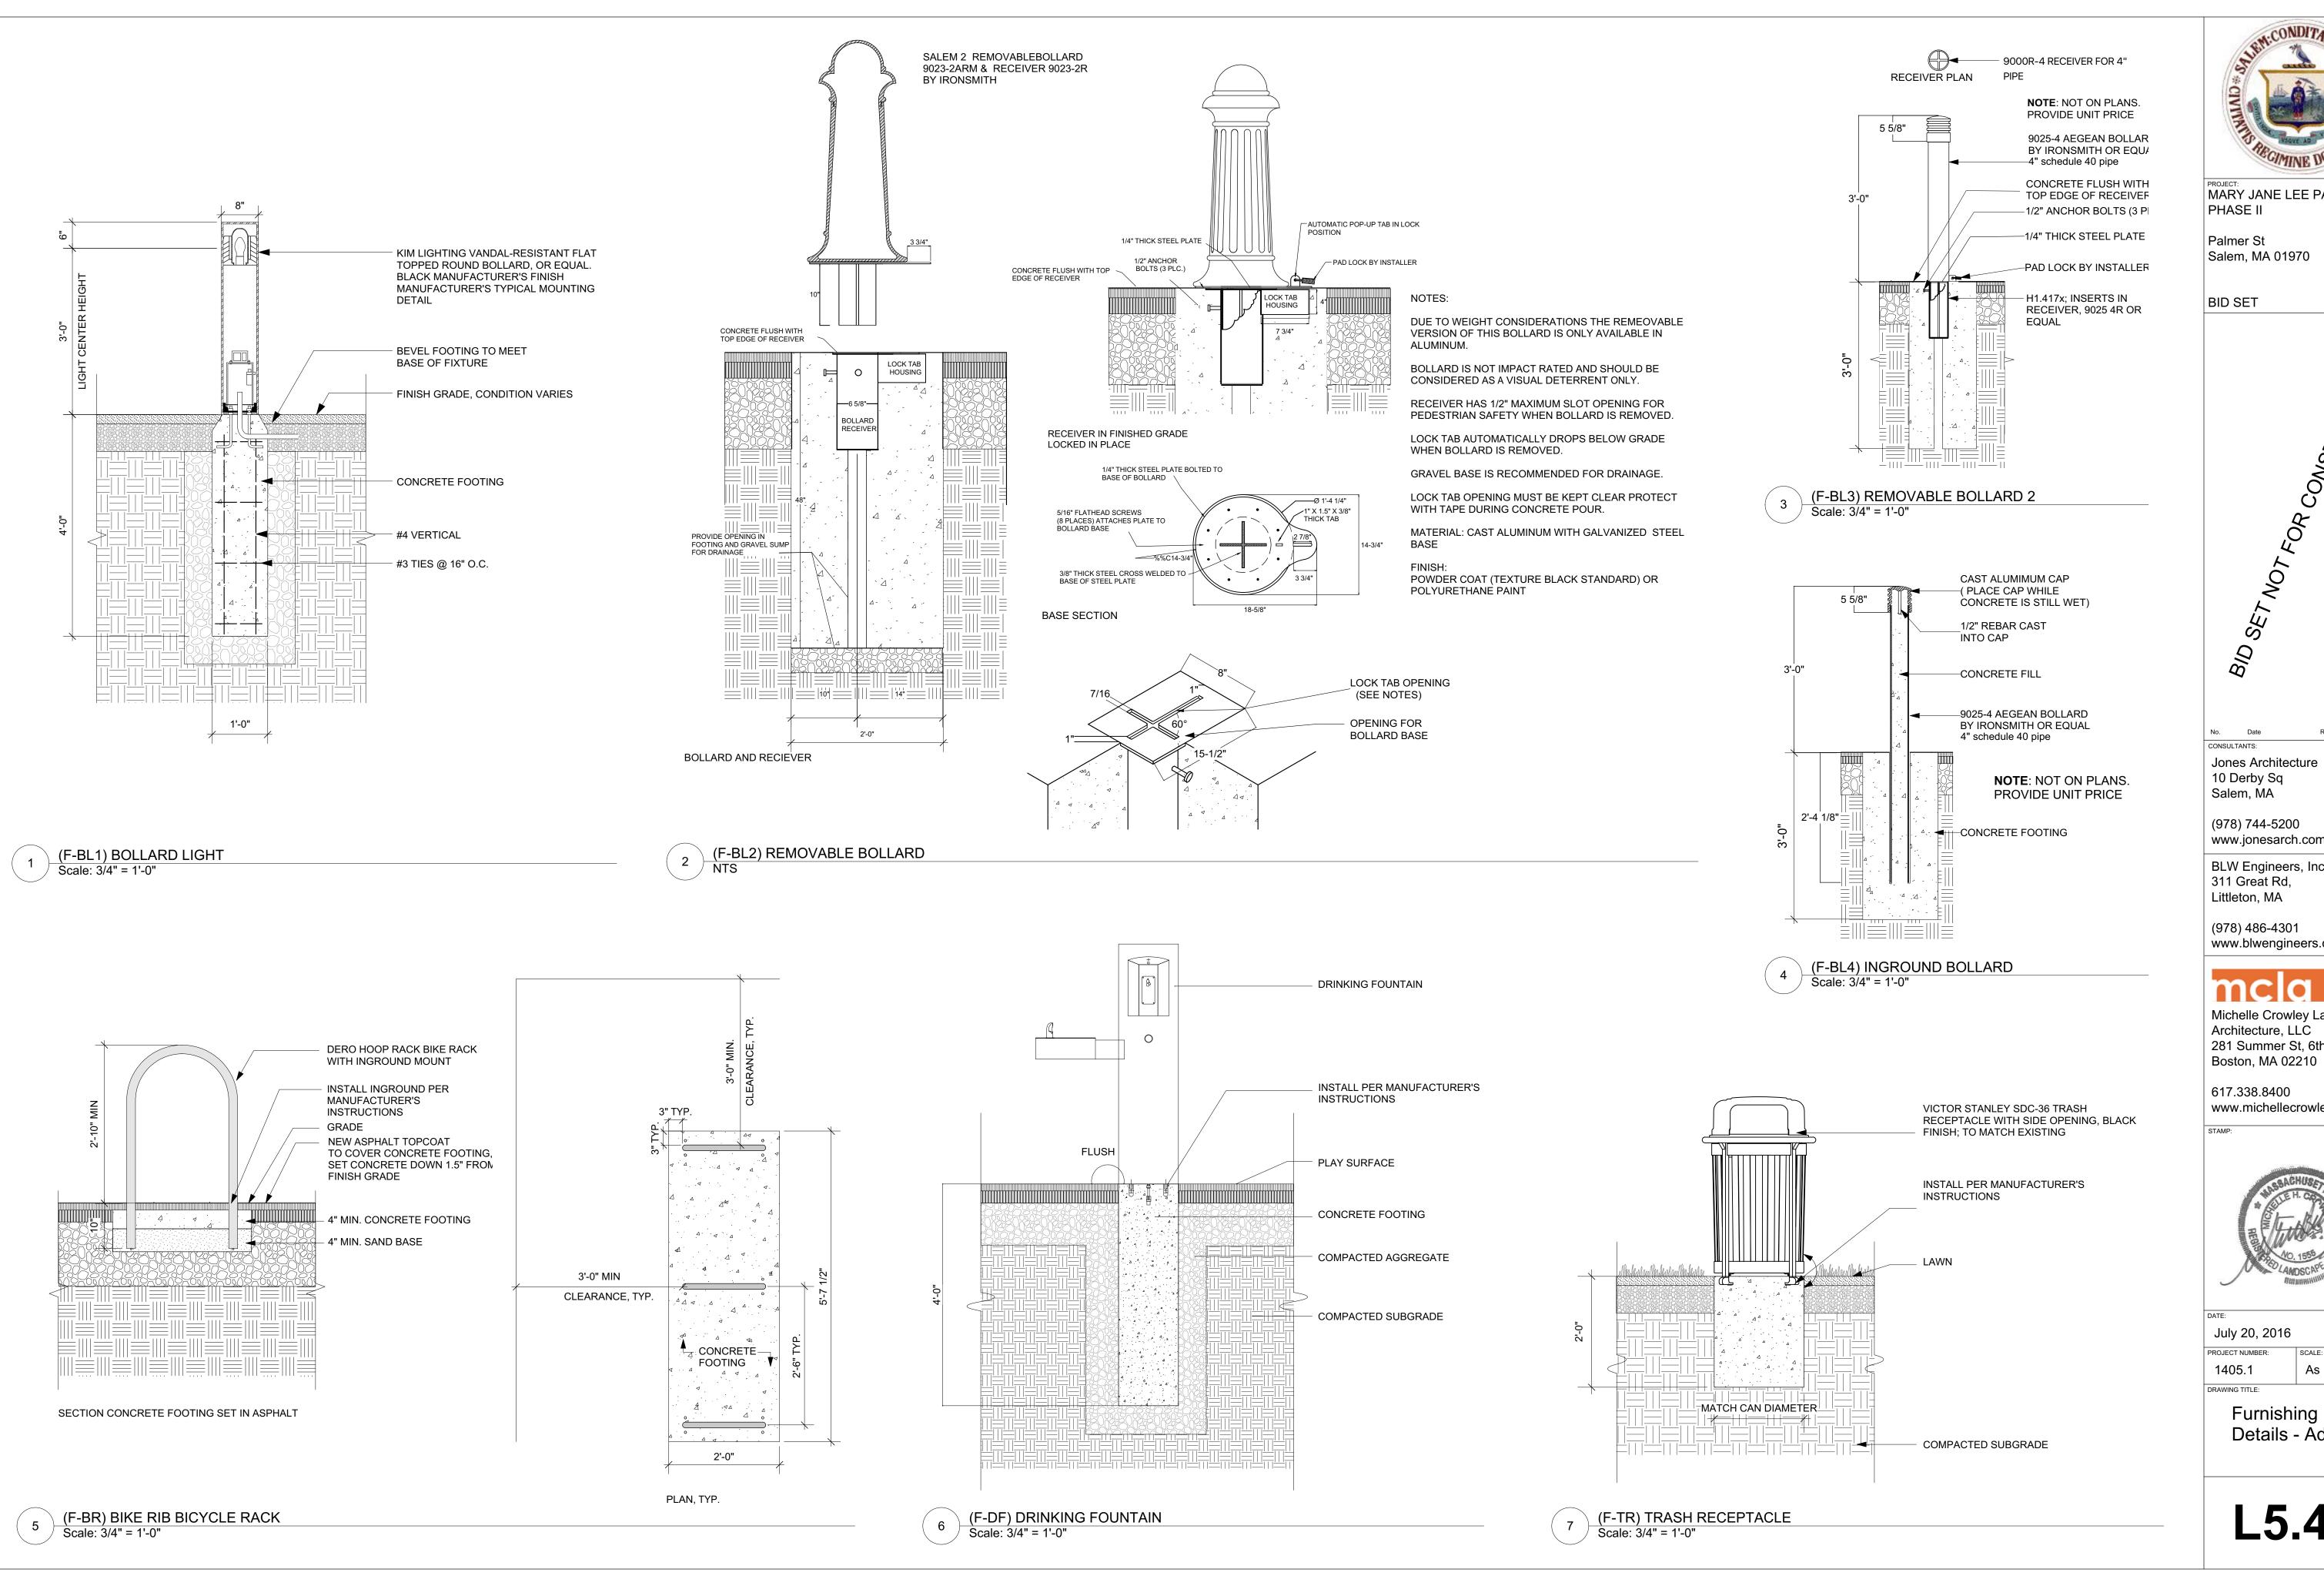
Furnishing Details- Fences



(F-F3) CHAIN LINK FENCE RENOVATION- NORTH
Scale: 3/8" = 1'-0"



(F-F4) CHAIN LINK FENCE RENOVATION- EAST Scale: 1/8" = 1'-0"

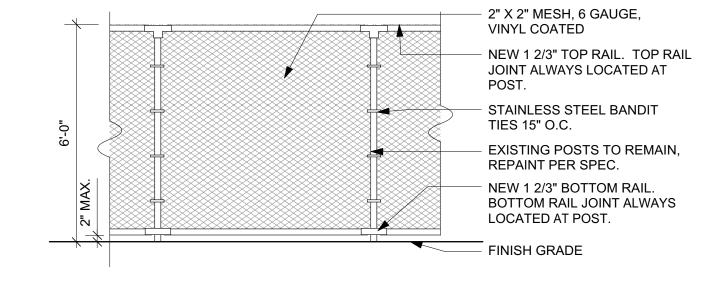



MARY JANE LEE PARK PHASE II

Palmer St Salem, MA 01970

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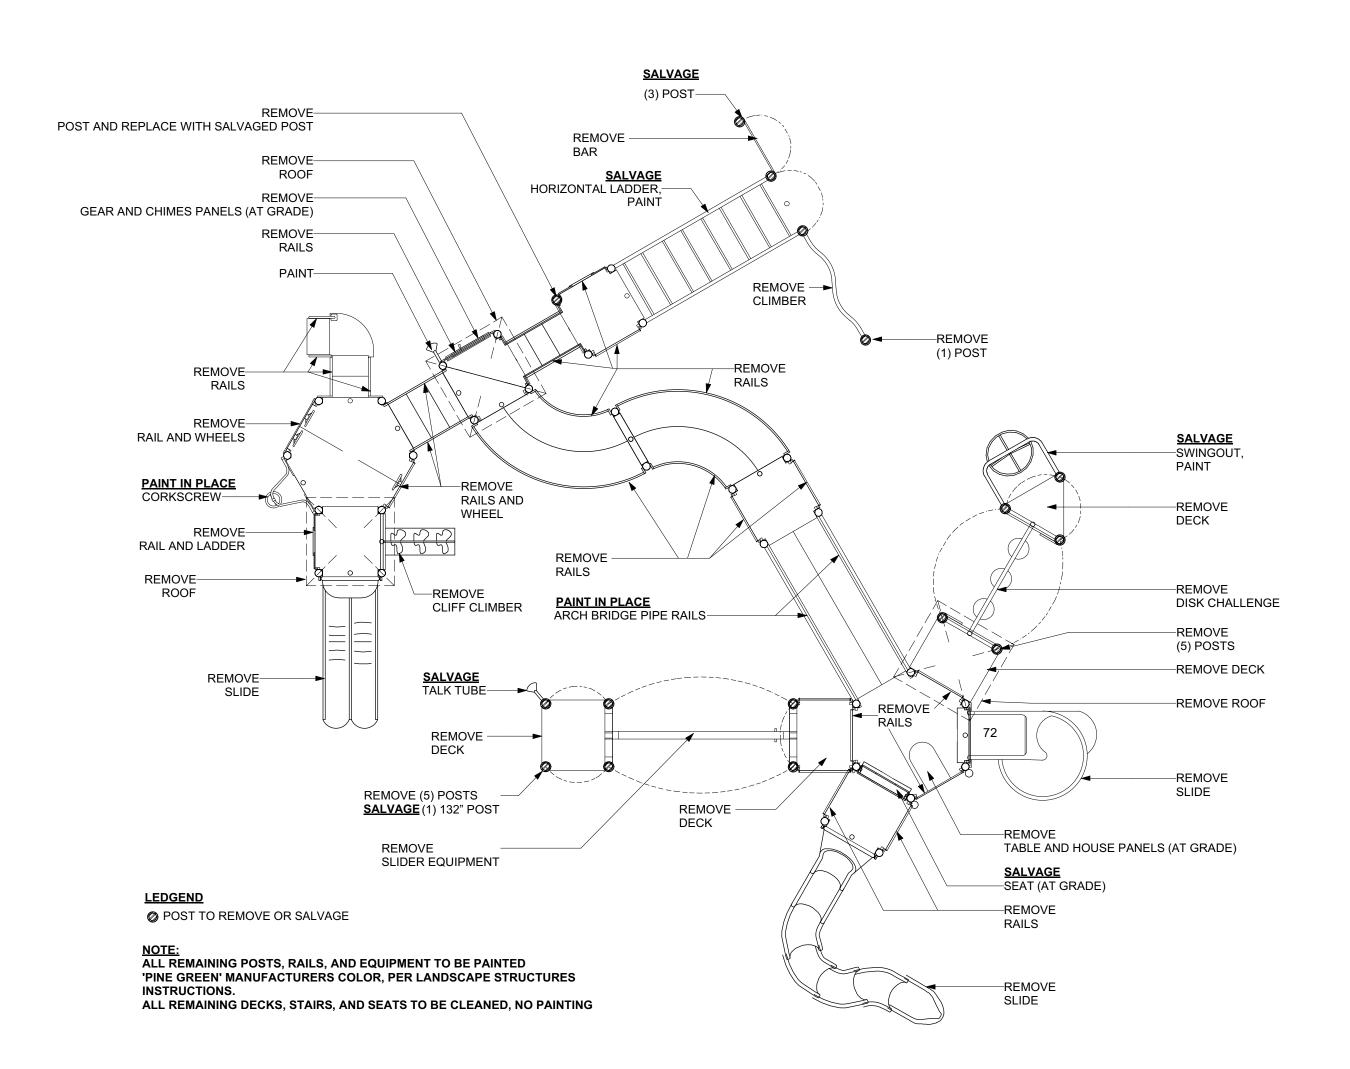
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July 20, 2016 1405.1 As Noted

Furnishing


Details - Additional



(F-PE1) PLAYBOOSTER- DEMOLITION AND SALVAGE
Scale: 3/16" = 1'-0"

# **GENERAL NOTES**

1. Existing conditions and topography data are combined from survey prepared by *North Shore Survey Corporation, 14 Brown St, Salem, MA, June 6, 2014* and Phase I construction documents. 2. Contractor shall verify location of any existing utilities and services and provide protection during construction. Utilities damaged during construction shall be repaired at contractors expense. 3. Contractor shall obtain permits for the work as required and comply with all laws, ordinances, rules and regulations of the local jurisdiction, the state, and all other authorities having jurisdiction. 4. Contractor shall leave site clean and orderly during construction process. Remove from site all excess materials, soil, debris and equipment. Store materials only in an approved location.

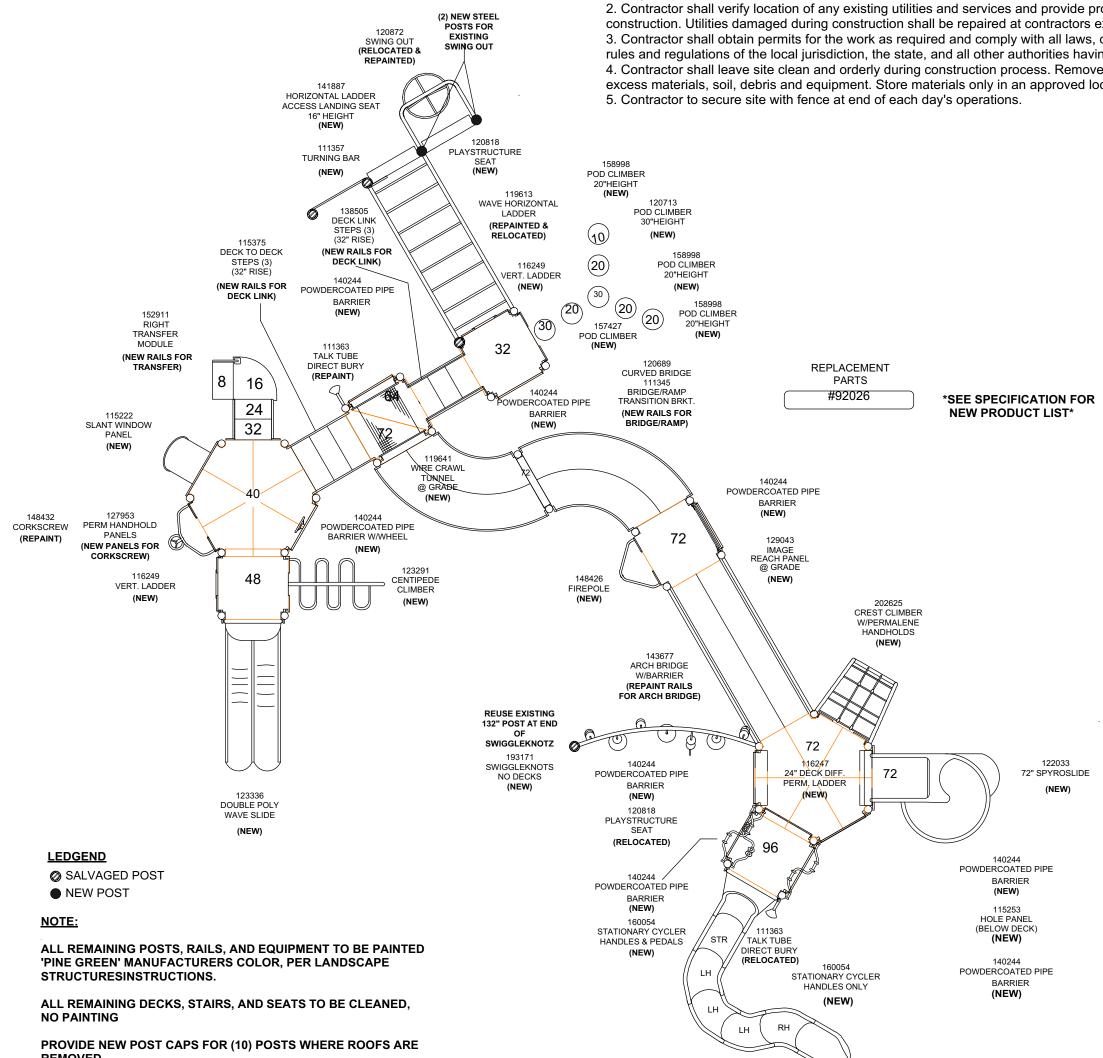


(F-PE1) PLAYBOOSTER- NEW CONFIGURATION
Scale: 3/16" = 1'-0"



MARY JANE LEE PARK PHASE II

Palmer St Salem, MA 01970

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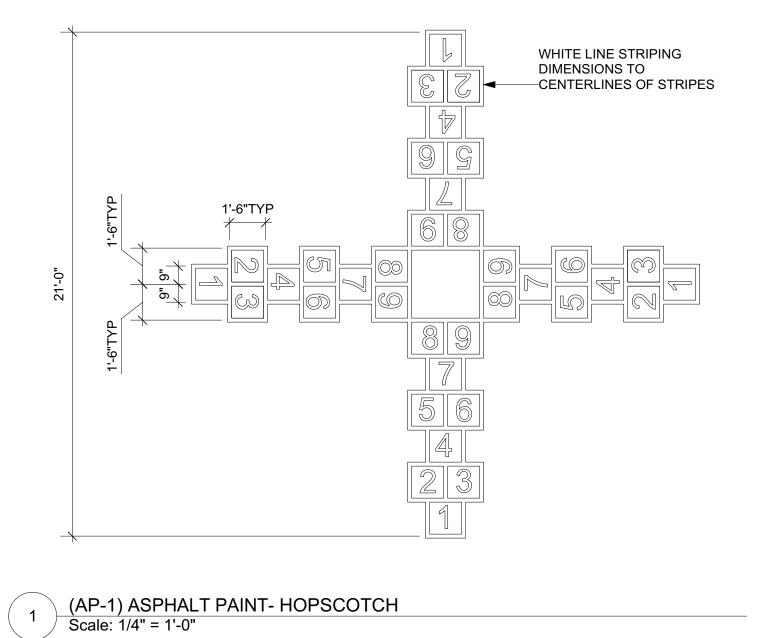


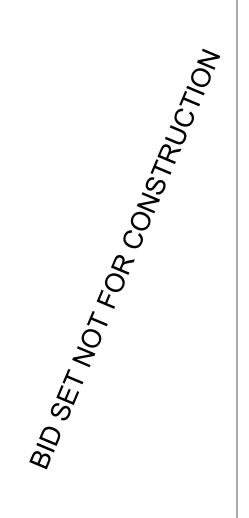
July 20, 2016

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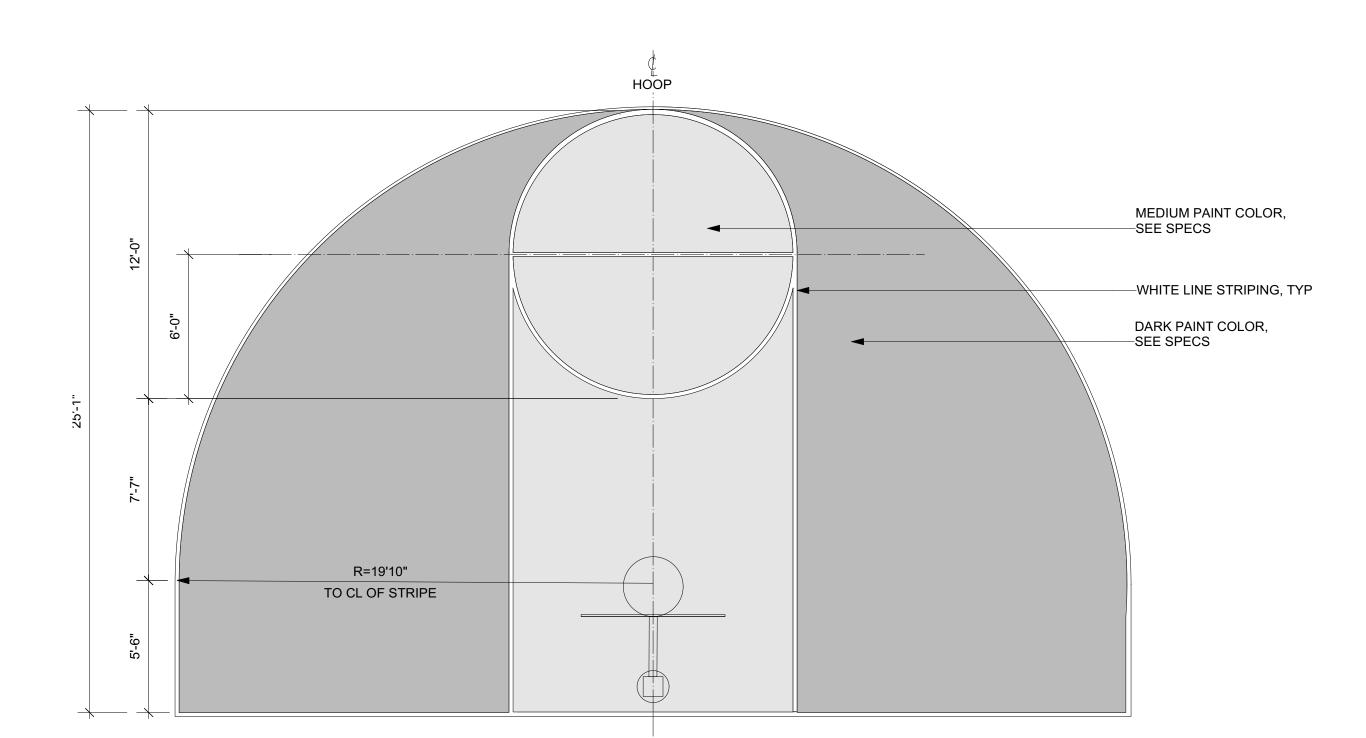
As Noted


PlayBooster Details



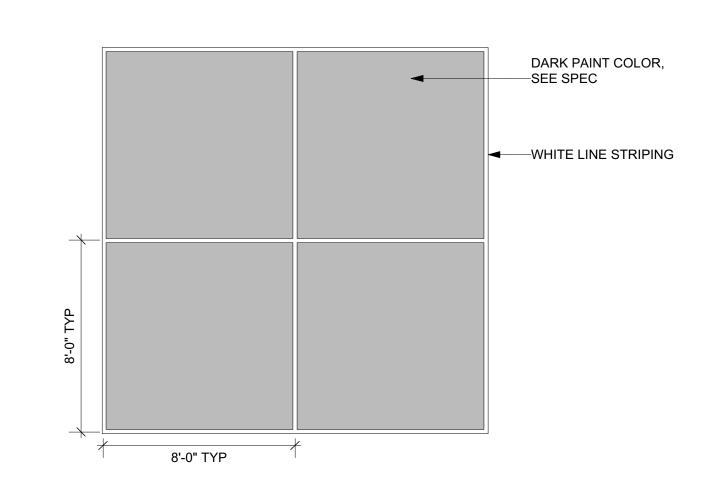

2 (AP-2) ASPHALT PAINT- FOUR SQUARE Scale: 1/4" = 1'-0"



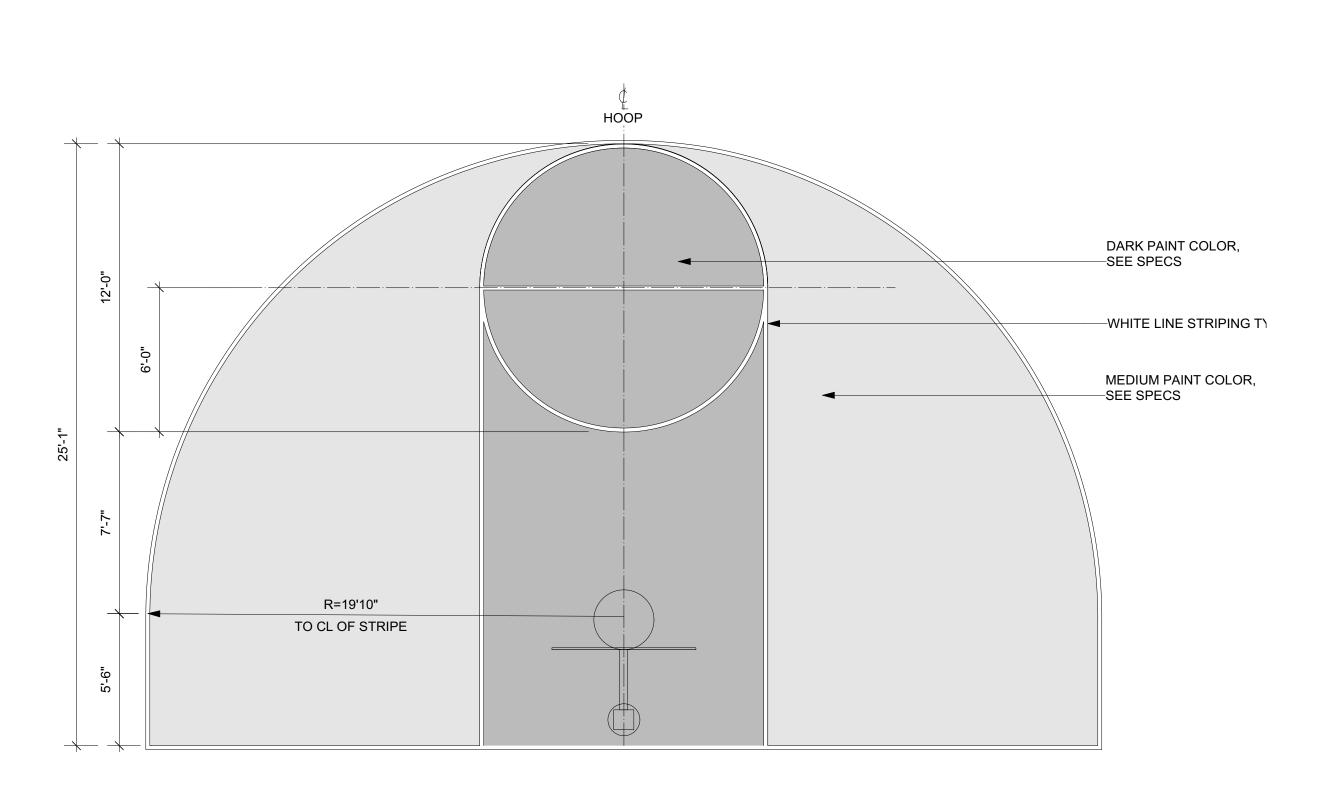


(AP-3) ASPHALT PAINT- BASKETBALL COLOR 1 Scale: 1/4" = 1'-0" (AP-4) ASPHALT PAINT- BASKETBALL COLOR 2
Scale: 1/4" = 1'-0"



PROJECT:
MARY JANE LEE PARK
PHASE II

Palmer St Salem, MA 01970

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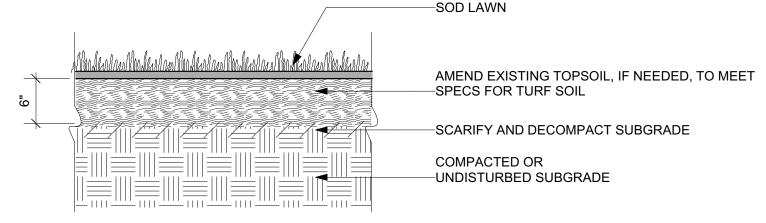
July 20, 2016

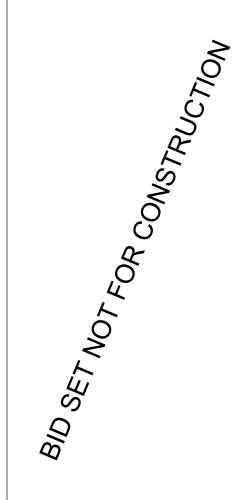
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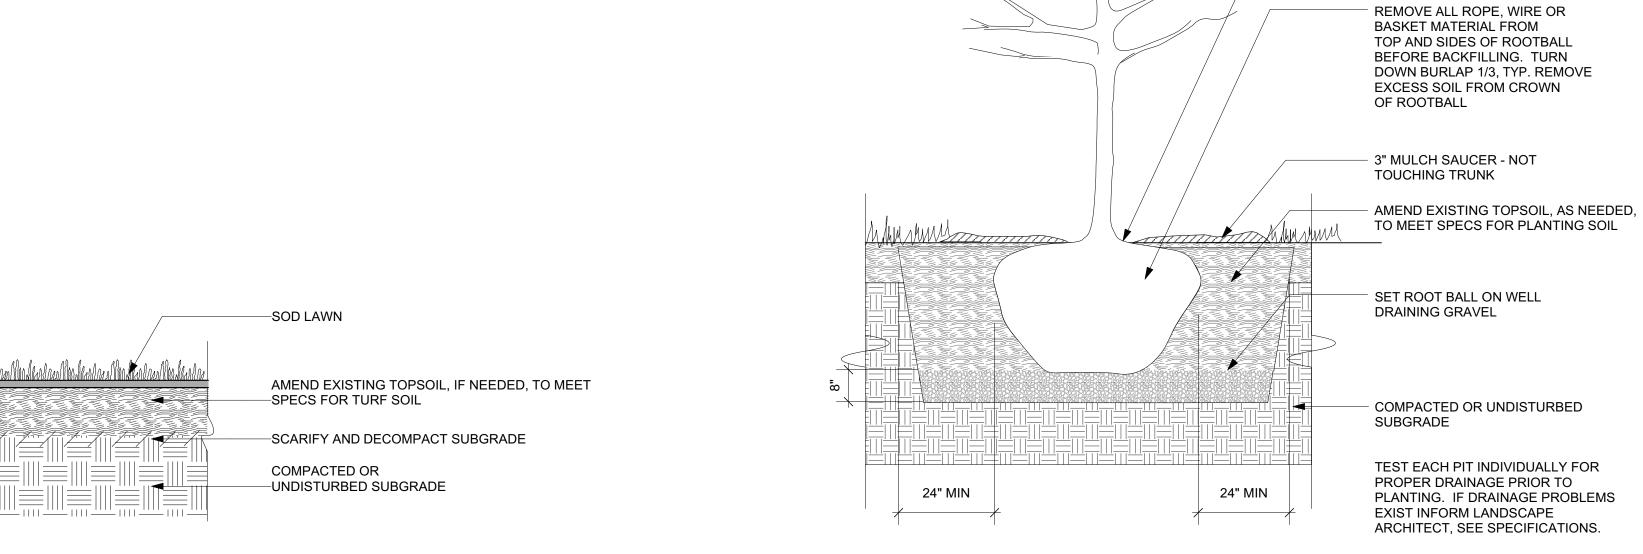
PROJECT NUMBER: SCALE:

1405.1 As Noted

Asphalt Paint Details





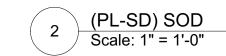

(PL-TR) TREE
Scale: 1/2" = 1'-0"




MARY JANE LEE PARK PHASE II

Palmer St Salem, MA 01970

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SET ROOT FLARE/CROWN ABOVE FINISH GRADE ONCE LOCATION AND DEPTH HAS BEEN APPROVED BY L.A

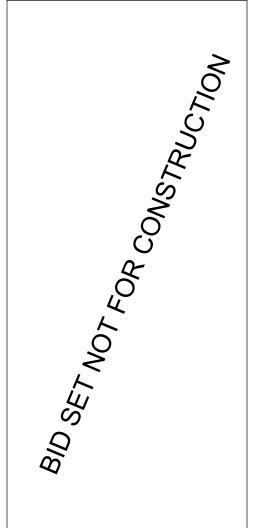

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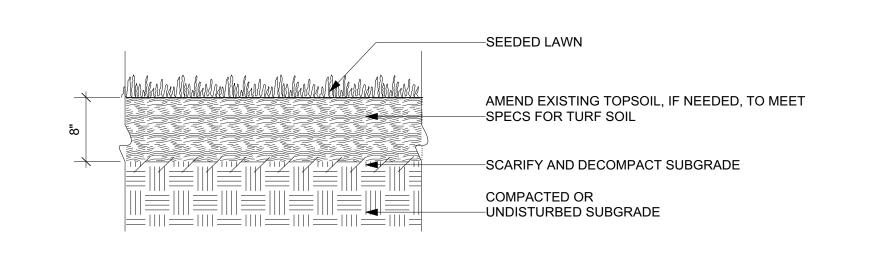
July 20, 2016

1405.1


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As Noted


Planting Details






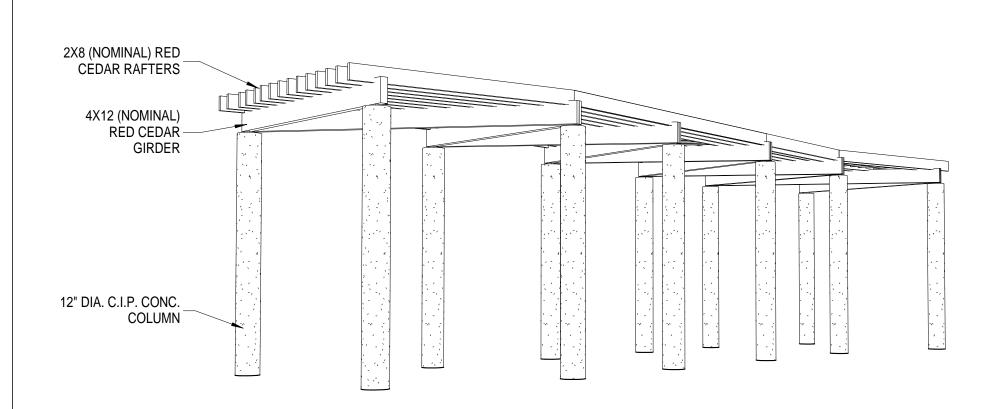

9 PERSPECTIVE VIEW FROM SOUTH WEST

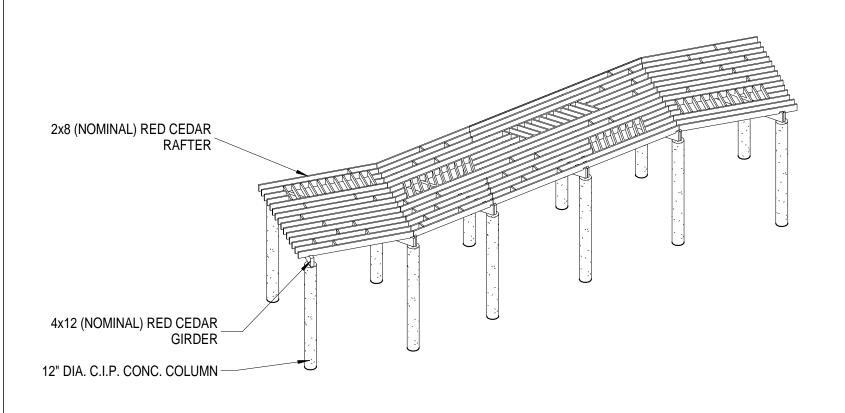


5 ORTHO BIRDSEYE VIEW FROM SOUTH WEST

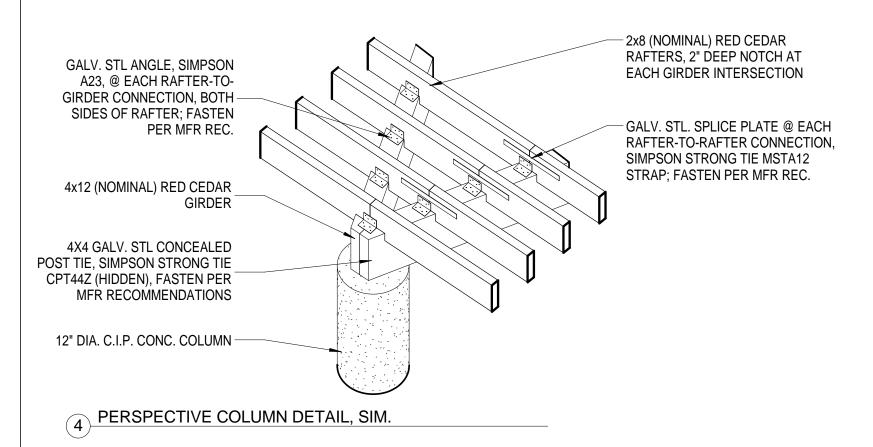


# **GENERAL NOTES**

1. ALL WOOD MEMBERS SURFACED FOUR SIDES (S4S)

2. ALL STL CONNECTORS TO BE GALVANIZED

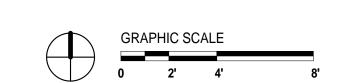

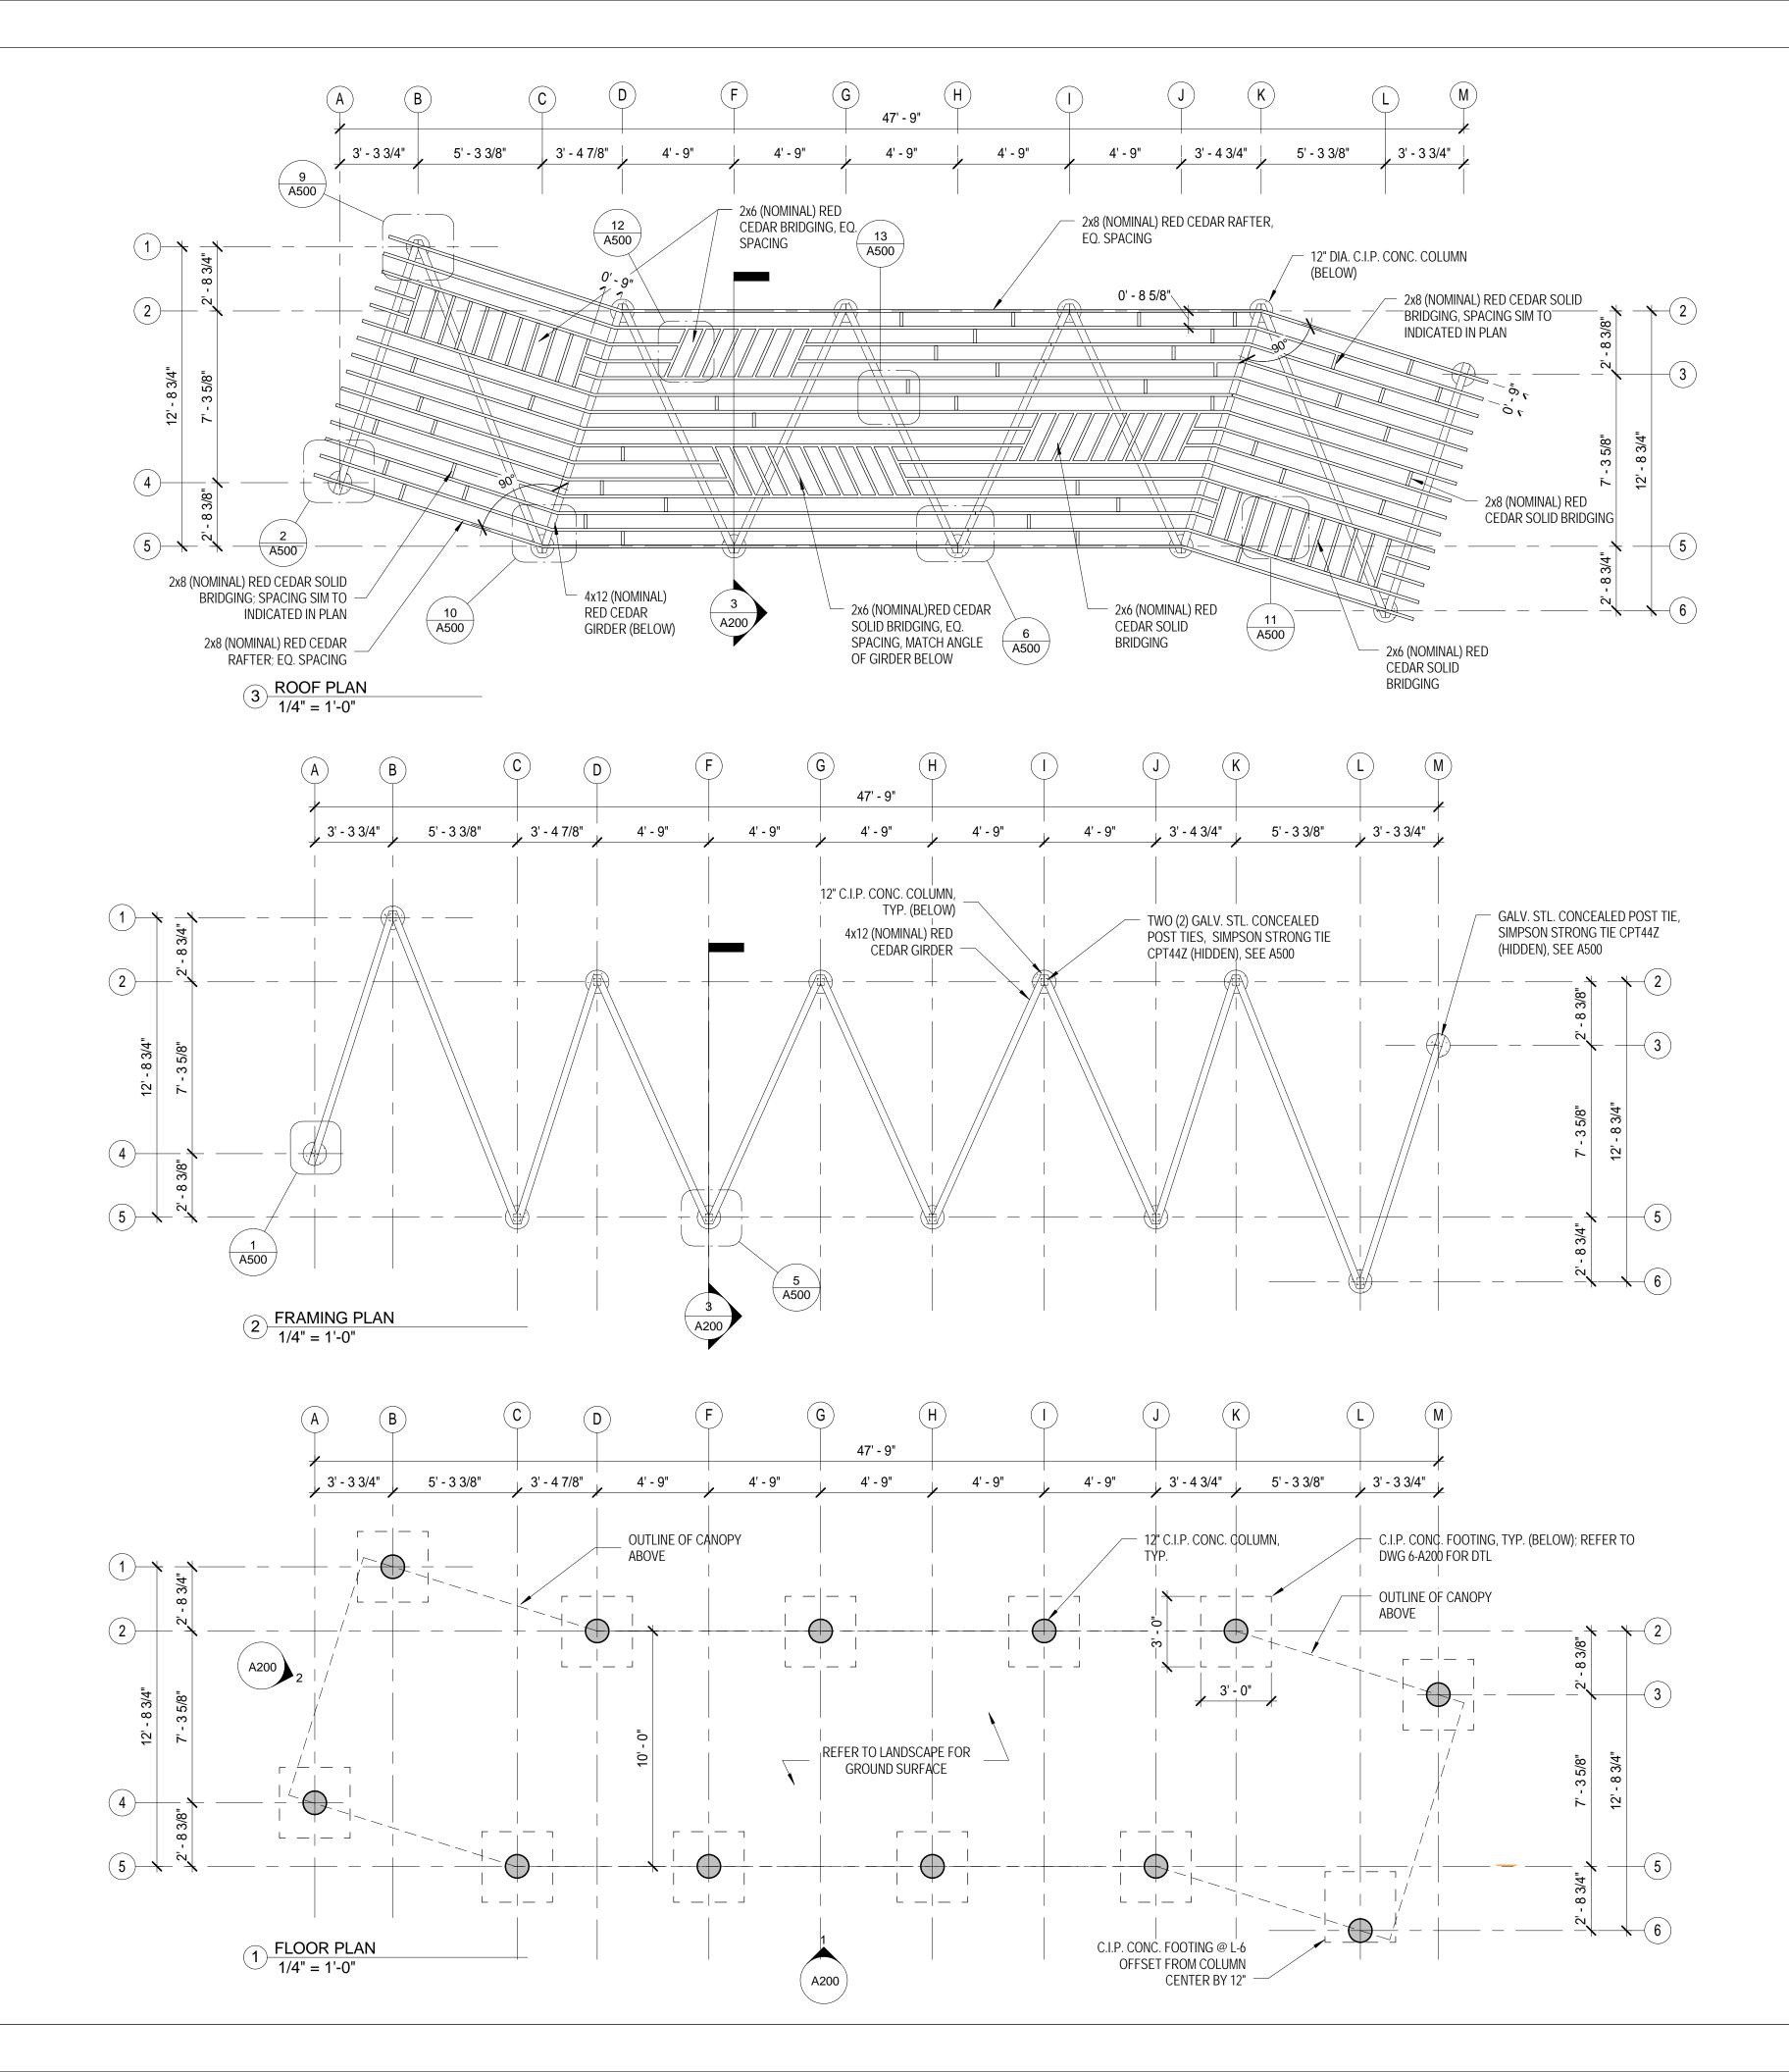



MARY JANE LEE PARK PHASE II

Palmer St Salem, MA 01970

BID SET



Jones Architecture, INC

Salem, MA 01970 978.744.5200

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10 Derby Square

Michelle Crowley Landscape Architecture, LLC 281 Summer St, 6th Floor Boston, MA 02210


617.338.8400 www.michellecrowley-la.com

JULY 20, 2016

PROJECT NUMBER: 1405.1

As indicated PAVILION PLANS & 3D VIEWS

# GENERAL NOTES 1. ALL WOOD MEMBERS SURFACED FOUR SIDES (S4S) 2. ALL STL CONNECTORS TO BE GALVANIZED PROJECT: MARY JANE LEE PARK PHASE II Palmer St

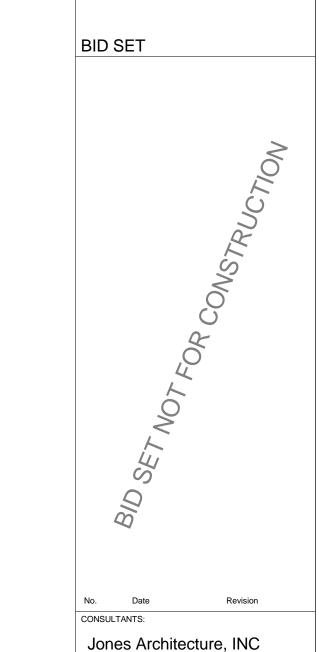

10 Derby Square Salem, MA 01970

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Salem, MA 01970

Michelle Crowley Landscape
Architecture, LLC

Boston, MA 02210
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281 Summer St, 6th Floor

STAMP:

DATE:

JULY 20, 2016

PROJECT NUMBER: SCALI


1405.1 As indicated

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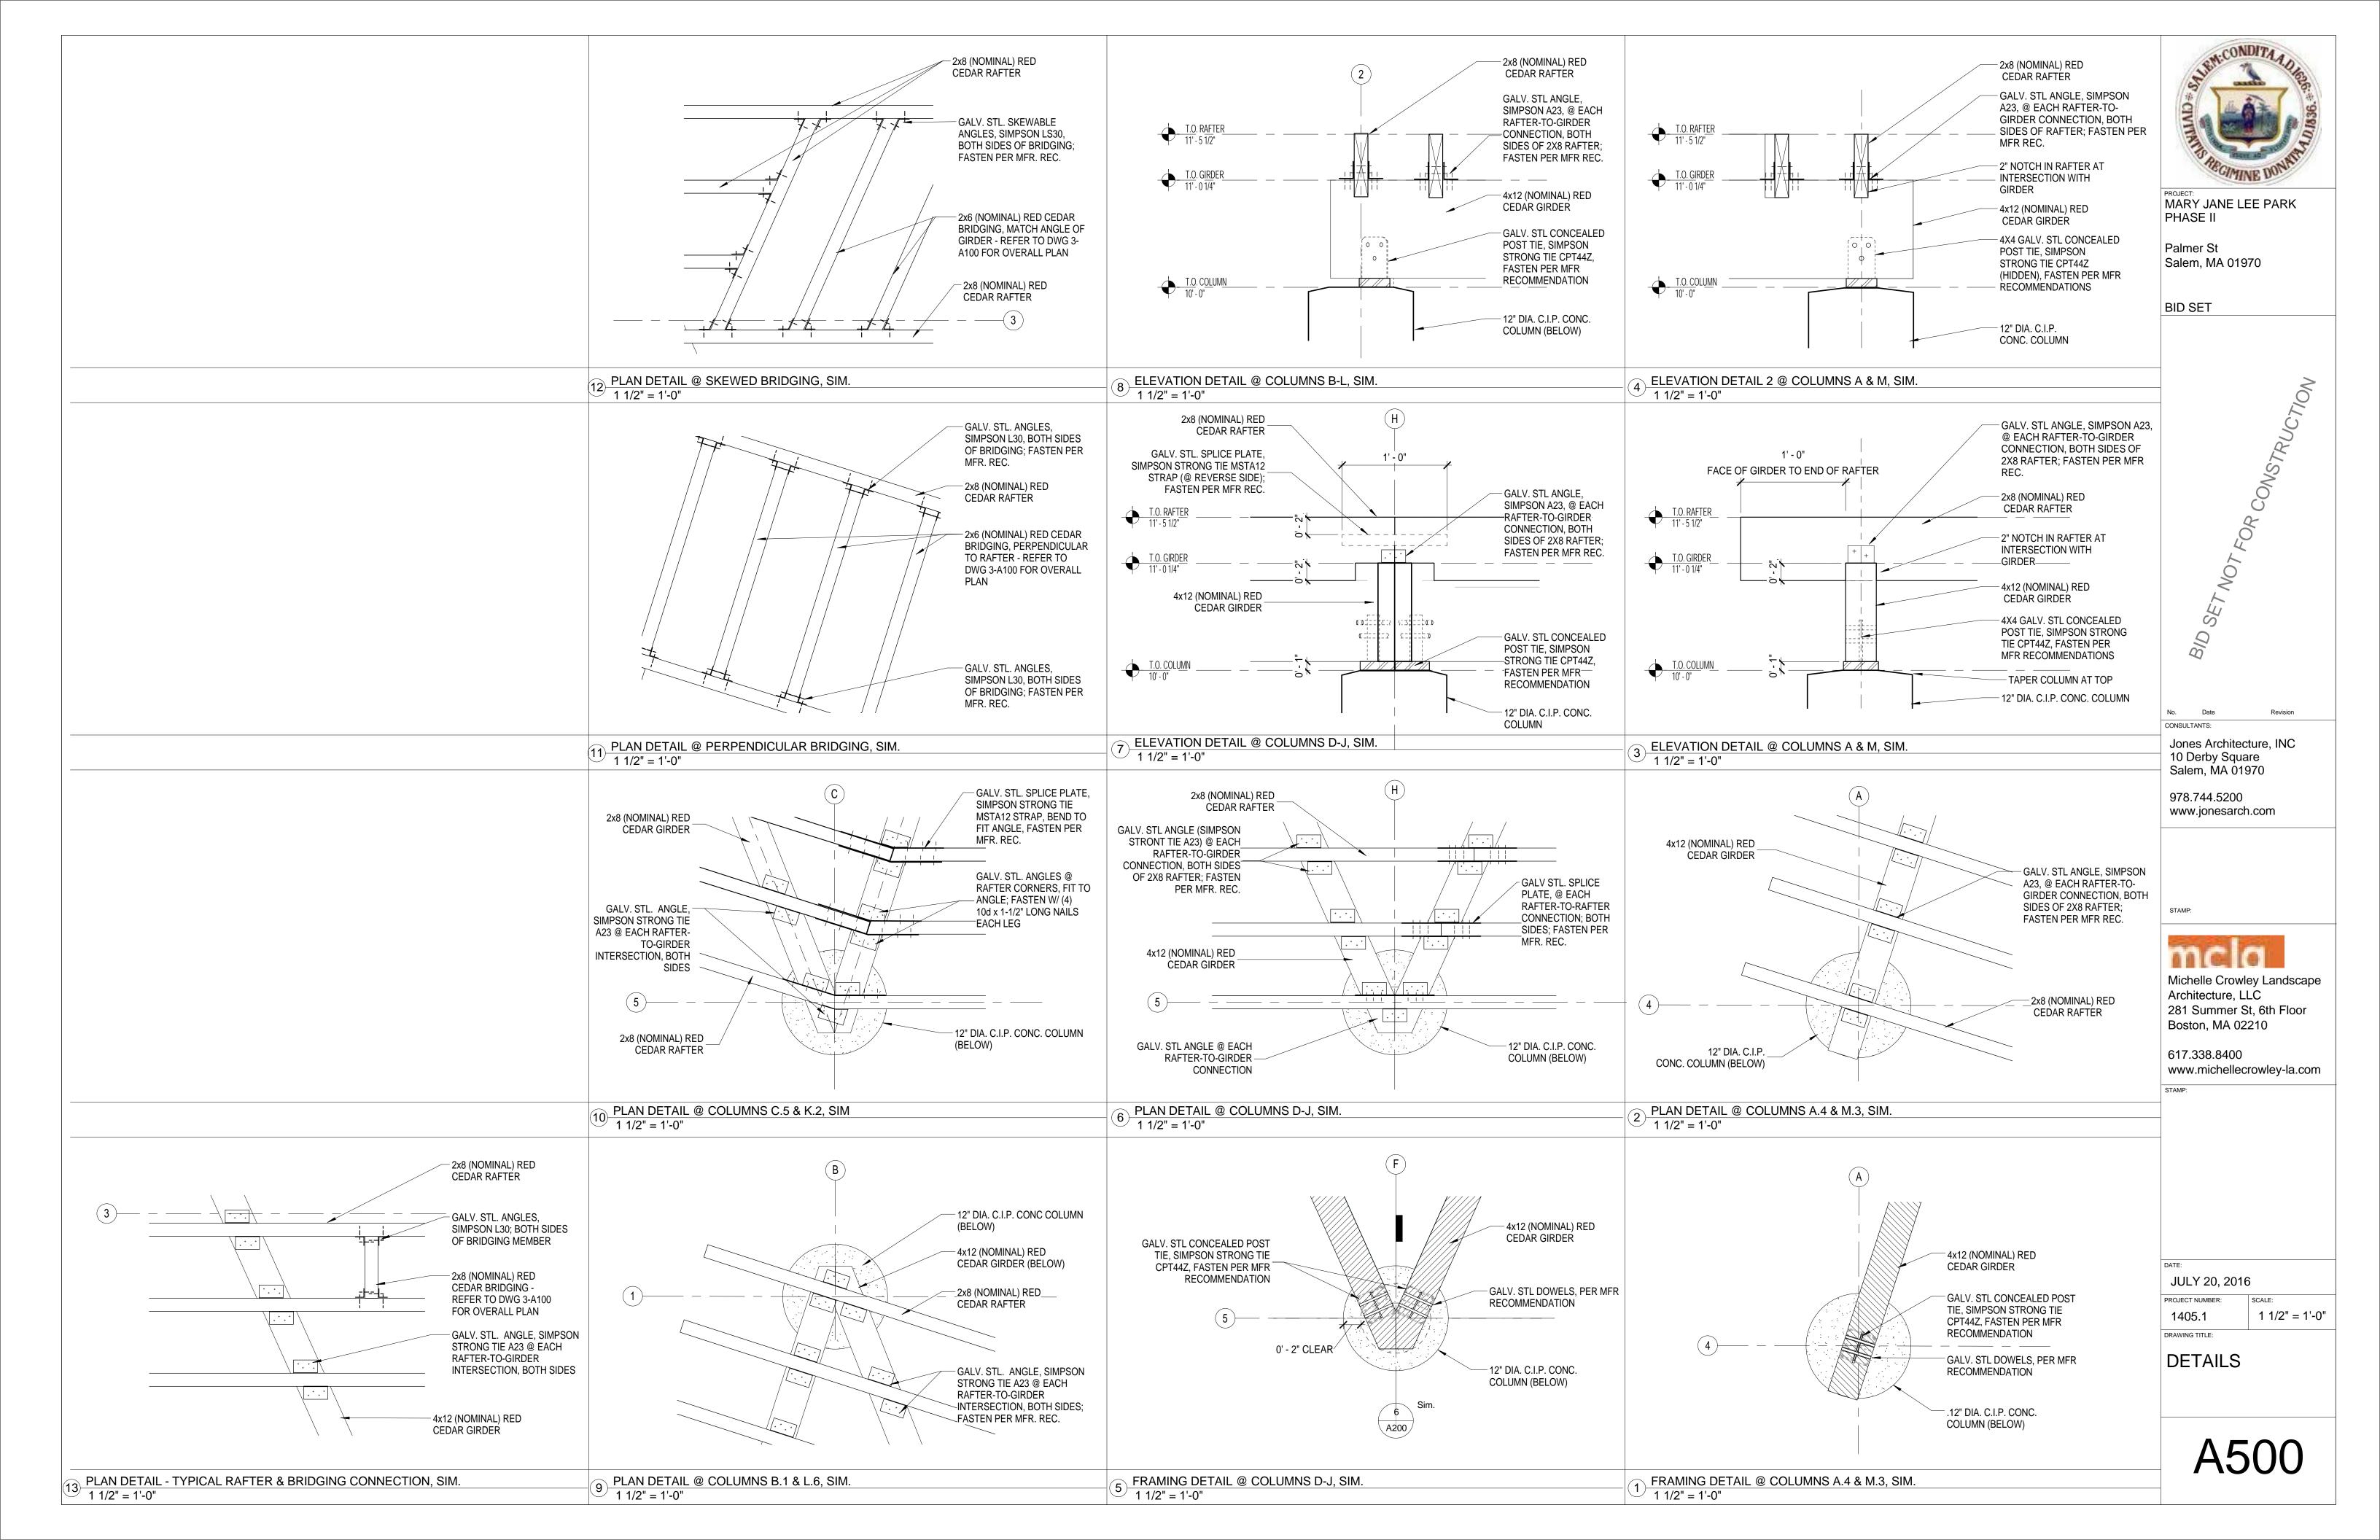
ELEVATIONS &

**COLUMN DETAIL** 

**Λ200** 

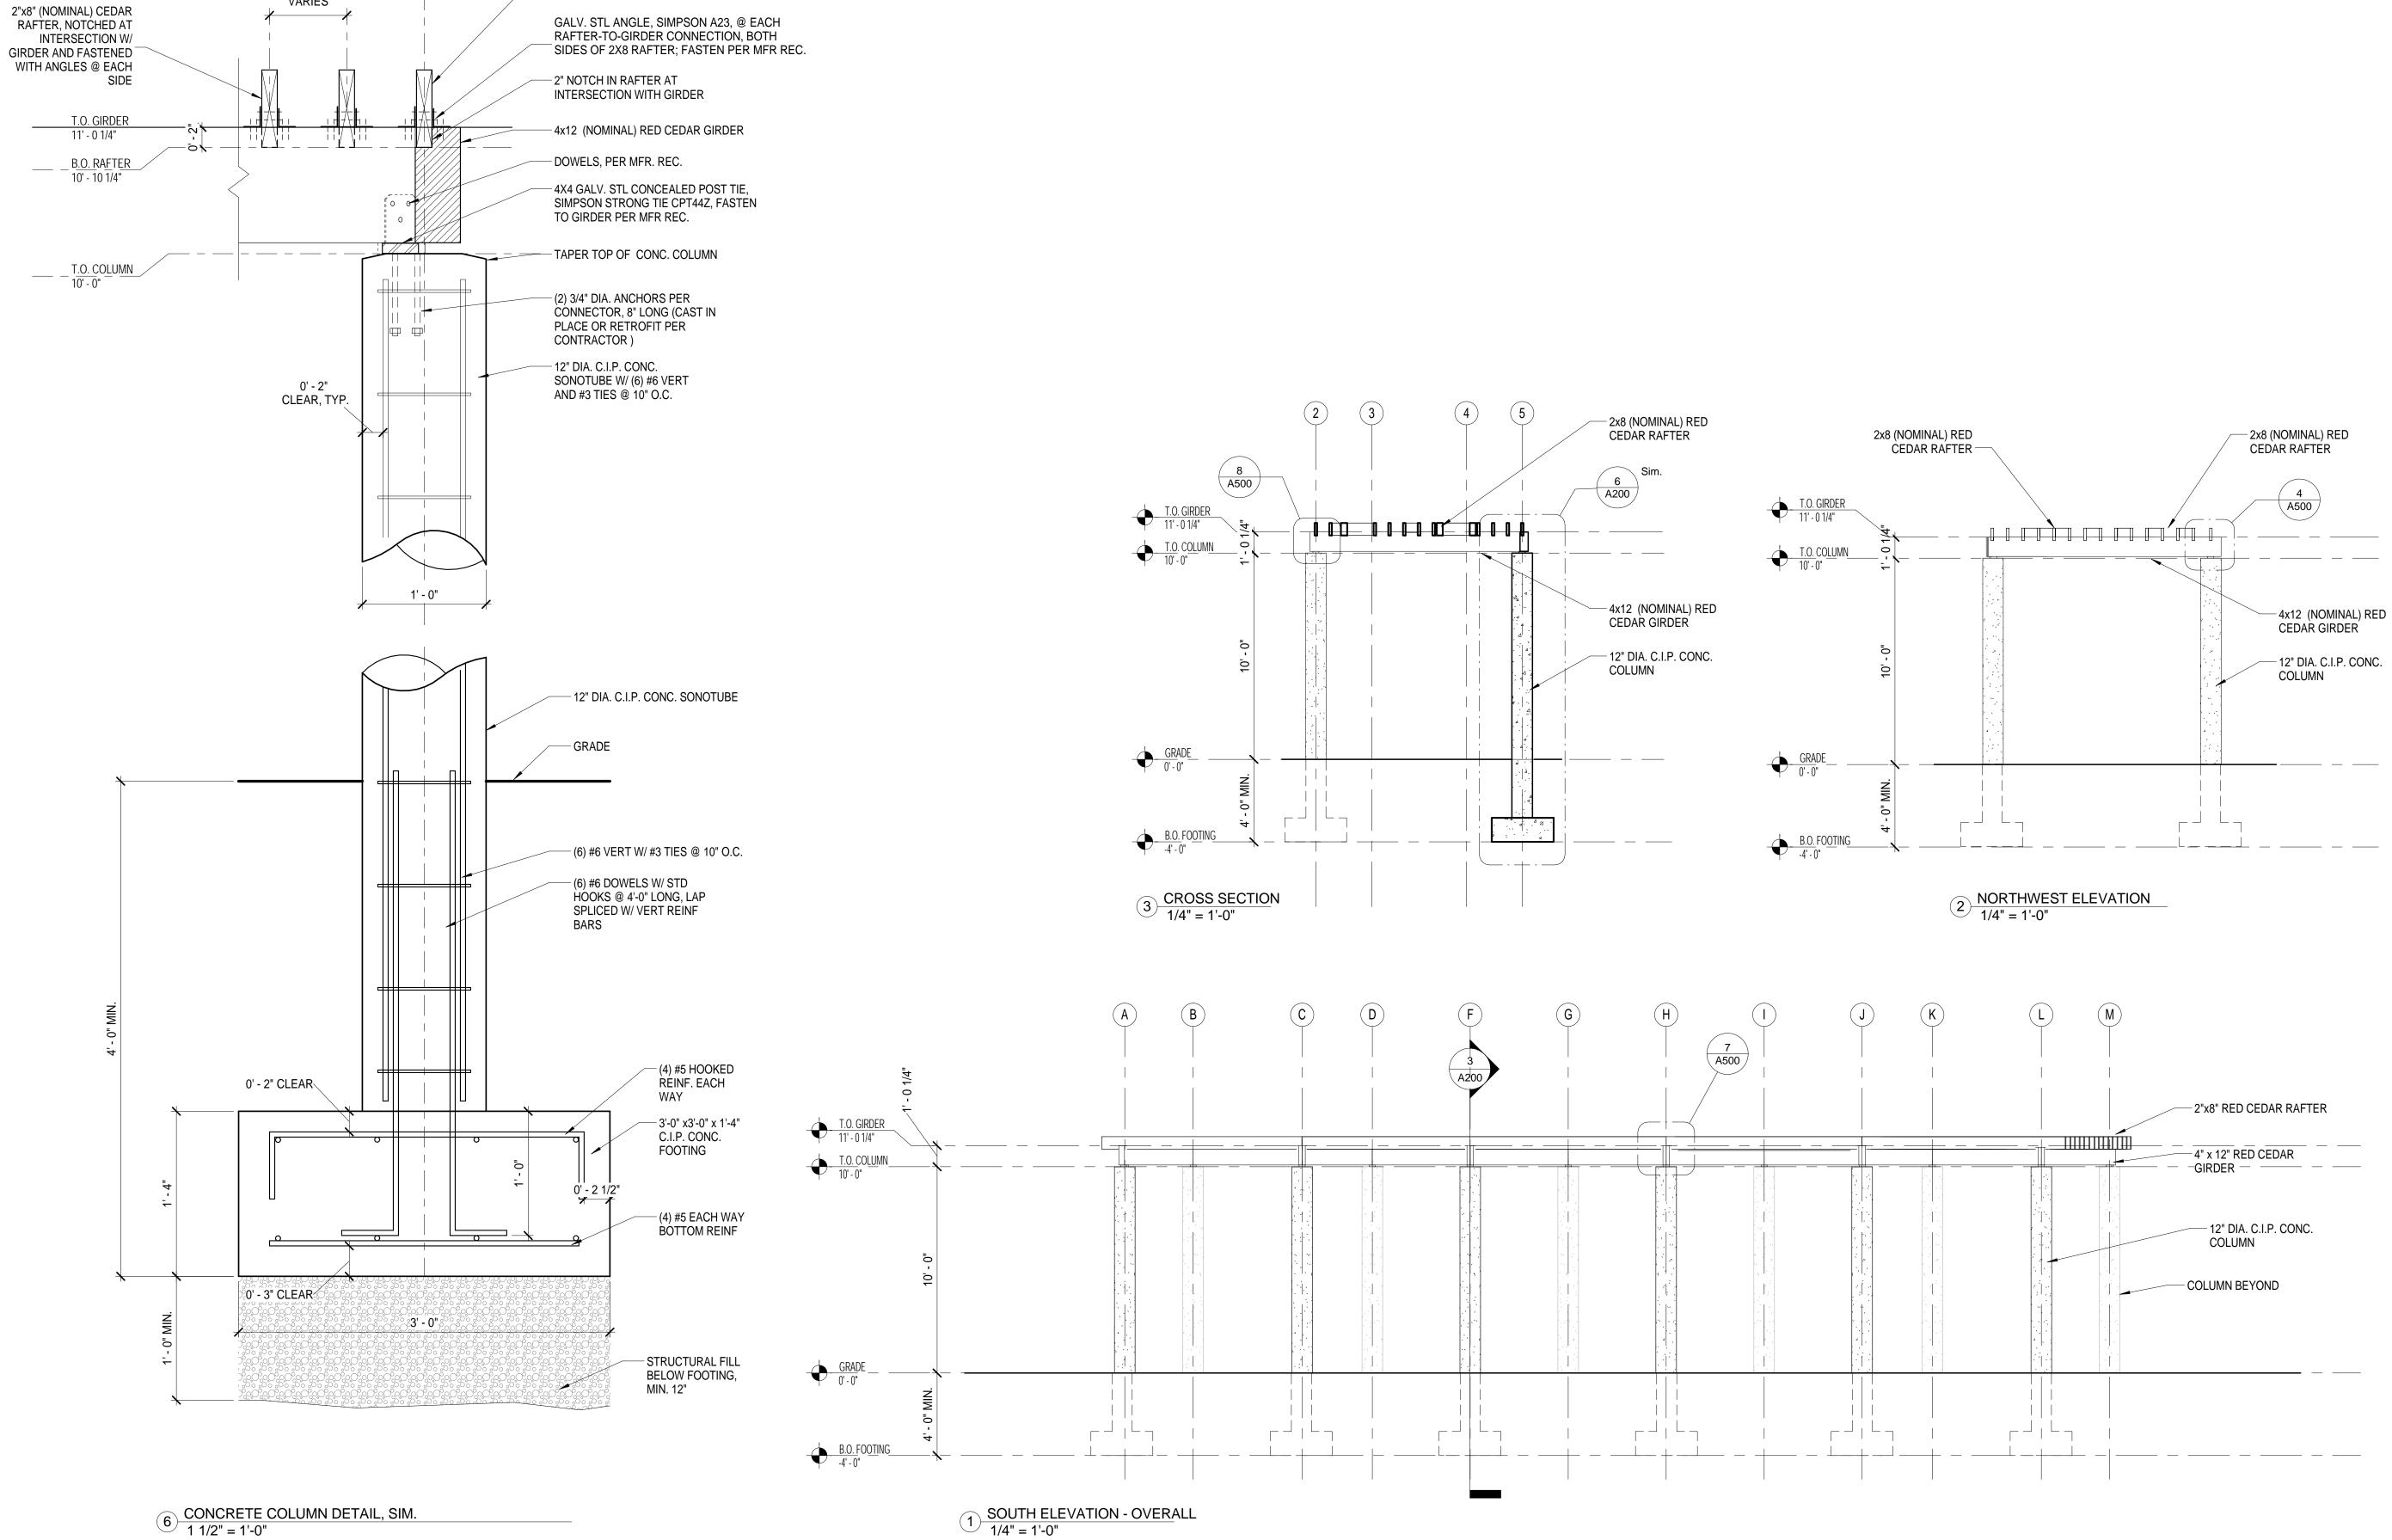

- 2x8 (NOMINAL) RED CEDAR RAFTER



# **GENERAL SPECIFICATIONS**

- 1. CONDITIONS OF THE CONTRACT AND DIVISION 1, GENERAL REQUIREMENTS APPLY TO WORK SHOWN ON THESE DRAWINGS. EXAMINE DRAWINGS AND OTHER SPECIFICATIONS FOR REQUIREMENTS THAT AFFECT WORK SHOWN ON THESE DRAWINGS.
- 2. PROVIDE ITEMS REFERRED TO IN SINGULAR NUMBER IN CONTRACT DOCUMENTS IN QUANTITIES NECESSARY TO COMPLETE
- 3. VISIT SITE AND EXAMINE CONDITIONS UNDER WHICH WORK MUST BE PERFORMED. REPORT ADVERSE CONDITIONS IN WRITING TO ENGINEER. COMMENCEMENT OF WORK SHALL BE CONSTRUED AS COMPLETE ACCEPTANCE OF EXISTING CONDITIONS INCLUDING PREPARATORY WORK DONE BY OTHERS.
- 4. PERFORM WORK AND PROVIDE MATERIALS AND EQUIPMENT AS SHOWN ON DRAWINGS. COORDINATE ELECTRICAL WORK WITH WORK SHOWN ON THESE DRAWINGS.
- 5. GIVE NOTICES, FILE PLANS, OBTAIN PERMITS AND LICENSES, PAY FEES AND BACK CHARGES, AND OBTAIN NECESSARY APPROVALS FROM AUTHORITIES THAT HAVE JURISDICTION.
- 6. PERFORM WORK AS REQUIRED BY CODES, REGULATIONS AND LAWS OF LOCAL, STATE AND FEDERAL GOVERNMENTS AND OTHER AUTHORITIES WITH LAWFUL JURISDICTION.
- 7. MATERIAL AND EQUIPMENT SHALL BE UL, NEMA, ANSI, IEEE, ADA & CBM APPROVED FOR INTENDED SERVICE. MATERIAL AND INSTALLATION SHALL MEET REQUIREMENTS OF NATIONAL AND STATE ELECTRICAL CODE.
- 8. DRAWINGS ARE DIAGRAMMATIC AND INDICATE GENERAL ARRANGEMENT OF SYSTEMS.
- 9. UTILIZE EXITING MOLDED CASE CIRCUIT BREAKERS. MINIMUM INTERRUPTING CAPACITY SHALL BE 10,000 AMPS SYMMETRICAL AT 208 VOLTS.
- 10. ADDRESS QUESTIONS REGARDING DRAWINGS TO ARCHITECT IN WRITING BEFORE AWARD OF CONTRACT. OTHERWISE, ARCHITECT INTERPRETATION OF MEANING AND INTENT OF DRAWINGS SHALL BE FINAL.
- 11. SUBMIT SHOP DRAWINGS AND PRODUCT DATA WITHIN TEN (10) DAYS AFTER AWARD OF CONTRACT. CHECK, STAMP AND MARK WITH PROJECT NAMES SUBMITTALS BEFORE TRANSMITTING TO ENGINEER. INDICATE DEVIATIONS FROM CONTRACT DOCUMENTS. SHOP DRAWINGS SHALL BE PROVIDED FOR ALL EQUIPMENT SHOWN ON THE DRAWINGS. PROVIDE SHOP DRAWINGS ON LIGHTING, CIRCUIT BREAKERS, CONDUIT, WIRING DEVICES, TIME CLOCK, PHOTOCELL, CABLE AND
- 12. SCHEDULE AT LEAST FIVE (5) WORKING DAYS, EXCLUSIVE ON TRANSMITTAL TIME FOR SUBMITTAL REVIEW.
- 13. ALL WIRING SHALL BE RUN CONCEALED UNLESS SPECIFIED OTHERWISE.
- 14. CONTRACTOR SHALL REVIEW ALL TRADES' CONTRACT DOCUMENTS TO DETERMINE SPECIFIC MOUNTING LOCATIONS FOR ELECTRICAL EQUIPMENT. COORDINATE EXACT MOUNTING LOCATIONS WITH THE ENGINEER.
- 15. BRANCH CIRCUIT WIRING MAY NOT BE SHOWN GRAPHICALLY ON DRAWINGS AND MAY BE INDICATED BY CIRCUIT NUMBERS BESIDE FIXTURES, DEVICES AND EQUIPMENT. PROVIDE COMPLETE WIRING SYSTEM WHETHER OR NOT INDICATED GRAPHICALLY.
- 16. ALL NEW WIRING SHALL BE TYPE THHN/THWN RATED 75-90°C, 600V. WET-DRY LOCATIONS. MINIMUM BRANCH CIRCUIT WIRING SHALL BE NO. 10 AWG SOLID COPPER.
- 17. EXTERIOR WIRING SHALL BE IN GALVANIZED RIGID METALLIC CONDUIT AND PVC SCHEDULE 40.
- 18. ALL GROUNDING SHALL BE PERFORMED IN ACCORDANCE WITH THE NATIONAL ELECTRICAL CODE AS AMENDED BY THE STATE OF MASSACHUSETTS.
- 19. PROVIDE TYPED IDENTIFICATION DIRECTORY IN LOADCENTER INDICATING CIRCUIT FUNCTION OR EQUIPMENT SERVED.
- 20. ALL CONDUITS ARE SHOWN DIAGRAMMATICALLY. EXACT LOCATION AND METHOD OF SUPPORT SHALL BE DETERMINED IN THE FIELD, EXCEPT WHERE SPECIFIC DIMENSIONS AND DETAILS ARE SHOWN. ALL CONDUIT RUNS SHALL BE RIGIDLY SUPPORTED.
- 21. NO CONDUIT SMALLER THAN 3/4 INCH ELECTRICAL TRADE SIZE SHALL BE USED, UNLESS SPECIFICALLY CALLED FOR ON THE DRAWINGS.
- 22. PERFORM WORK AND PROVIDE MATERIALS AND EQUIPMENT TO MAKE INSTALLATION COMPLETE IN EVERY DETAIL UNDER THIS CONTRACT WHETHER OR NOT SPECIFICALLY SHOWN ON DRAWINGS.
- 23. CONDUCTORS AND CABLE SHALL BE MINIMUM #10 AWG, 600 VOLT, COPPER WITH TYPE THHN/THWN INSULATION. PROVIDE SEPARATE GREEN GROUND IN ALL BRANCH CIRCUITS. #10 AWG AND SMALLER SHALL BE SOLID. COLOR CODE CONDUCTORS BLACK, RED, BLUE, WITH WHITE NEUTRAL AND GREEN GROUND EXCEPT AS NOTED FOR 120 VOLT.

# **ABBREVIATIONS**

EMT ELECTRIC METALLIC CONDUIT SN S FLMT FLEXIBLE LIQUID TIGHT METALLIC TUBING SWBD S GC GENERAL CONTRACTOR TYP T GND GROUND V	RIGID STEEL CONDUIT SQUARE FOOT SOLID NEUTRAL SWITCHBOARD TYPICAL VOLTS VOLT—AMPERE
-------------------------------------------------------------------------------------------------------------------------------	-------------------------------------------------------------------------------------

# BRANCH CIRCUIT AND FEEDER SYMBOLS

BRANCH CIRCUIT DIAGONAL LINES INDICATE NUMBER OR CONDUCTORS, NO DIAGONAL LINES INDICATES TWO (2) CONDUCTORS (1 PHASE AND 1 NEUTRAL). GROUND WIRE(S) NOT INDICATED. MINIMUM SIZE CONDUCTOR #12 AWG AND 3/4" CONDUIT, UNLESS OTHERWISE NOTED

4#1,1#6G-1½"C INDICATES (3) #1 AWG(PHASE), (1)#1 AWG(NEUTRAL), (1) #6 GROUND IN A 1-1/2" CONDUIT

PP1-1 HOMERUN TO PANELBOARD 'P1' CIRCUIT NUMBER 1. DIAGONAL LINES INDICATE (1) PHASE AND (1) NEUTRAL CONDUCTOR. (1) GROUNDING CONDUCTOR UNDERSTOOD.

PP1-1,3 HOMERUN TO PANELBOARD 'P1' CIRCUIT NUMBER 1 & 3. DIAGONAL LINES INDICATE (2) PHASE AND (2) NEUTRAL CONDUCTOR. (2) GROUNDING CONDUCTOR UNDERSTOOD.

# LIGHTING FIXTURE SYMBOLS

VANDAL RESISTANT BOLLARD LIGHT FIXTURE, "B" DENOTES LIGHTING FIXTURE TYPE, "4" DENOTES CIRCUIT NUMBER. SEE DETAIL 1, THIS DRAWING.

# RECEPTACLES AND OUTLETS

DUPLEX GROUND FAULT INTERRUPTING RECEPTACLE, RATED 20A, 125V TYPE. "5" DENOTES CIRCUIT NUMBER, MOUNTING HEIGHT 18" TO CENTERLINE AFF

# LOADCENTER AND CONTROLS

POWER LOADCENTER, SURFACE MOUNTED, 120/208 VOLT

EQUIPMENT CONTROL PANEL

# SITE SYMBOLS

UNDERGROUND CONDUIT OR DUCTBANK



SECTION "A-A"

# **MISCELLANEOUS**

M

) OTILITI MIL

TC TIME CLOCK. SEE DETAIL 2, THIS DRAWING.

PHOTOCELL. SEE DETAIL 2, THIS DRAWING.

# GENERAL NOTES

- Existing conditions and topography data are from surveys prepared by North Shore Survey Corporation, 14 Brown St, Salem, MA, June 6, 2014.
   Contractor shall verify location of any existing utilities and services and provide
- protection during construction. Utilities damaged during construction shall be repaired at contractors expense.


  3. Contractor shall obtain permits for the work as required and comply with all laws, ordinances, rules and regulations of the local jurisdiction, the state, and all
- other authorities having jurisdiction.
  4. Contractor shall leave site clean and orderly during construction process.
  Remove from site all excess materials, soil, debris and equipment. Store materials only in an approved location.
- 5. Contractor to secure site with fence at end of each day's operations.



PROJECT: MARY JANE LEE PARK PHASE II


Palmer St Salem, MA 01970

BID SET

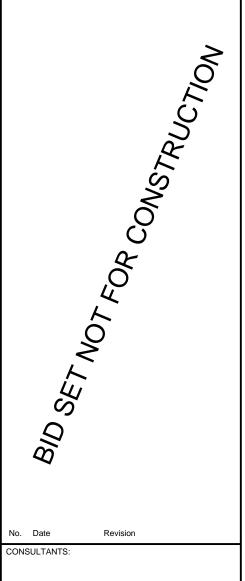

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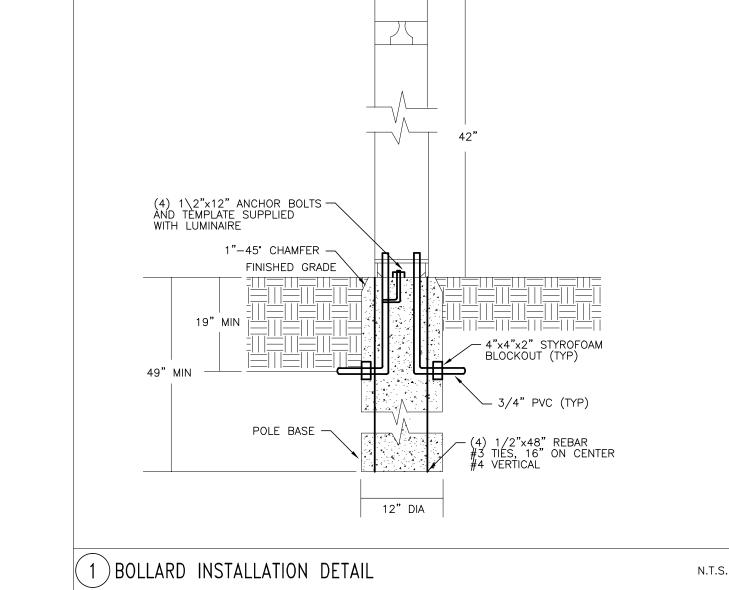
JULY 20, 2016

DRAWING TITLE:
ELECTRICAL
SPECIFICATIONS
SYMBOLS AND

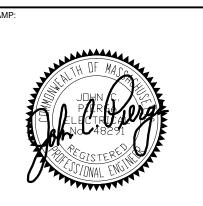F0 1

DETAILS

N.T.S.



FINISHED GRADE

COMPACTED SAND 6" (MIN)
ALL AROUND

OR SPECIFICATIONS

DIRECT BURIAL CONDUIT(S)

- YELLOW POLYETHYLENE COATED METALLIC CORE WARNING TAPE, FULL LENGTH OF TRENCH TO READ: "DANGER—BURIED ELECTRICAL LINE BELOW"

SUB BASE

TO LINE, REFER TO DRAWING FOR COMPLETE INFORMATION

1. INTERMATIC DIGITAL, SINGLE THROW, SEVEN DAY TIME SWITCH. NEMA 3R ENCLOSURE AND DIGITAL CLOCK MOTOR OF VOLTAGE COMPATIBLE WITH CONTROL CIRCUIT. 120 VOLT, TWO CIRCUIT MODEL No. V45471CR.


2. CABINET MOUNTED PHOTO—ELECTRIC CONTROL UNIT WITH OUTLET BOX AND FACE PLATE. INTERMATIC No. K4121M FOR 120 VOLT CONTROL CIRCUITS, FACE UNIT TO NORTH.

2 TIME SWITCH PHOTOCELL CONTROLLED CONTACTOR DETAIL

N.T.S. 3 DIRECT BURIAL CONDUIT DETAIL

BACKFILL OF SELECT — COMMON FILL COMPACTED IN LIFTS

UNDISTURBED EARTH

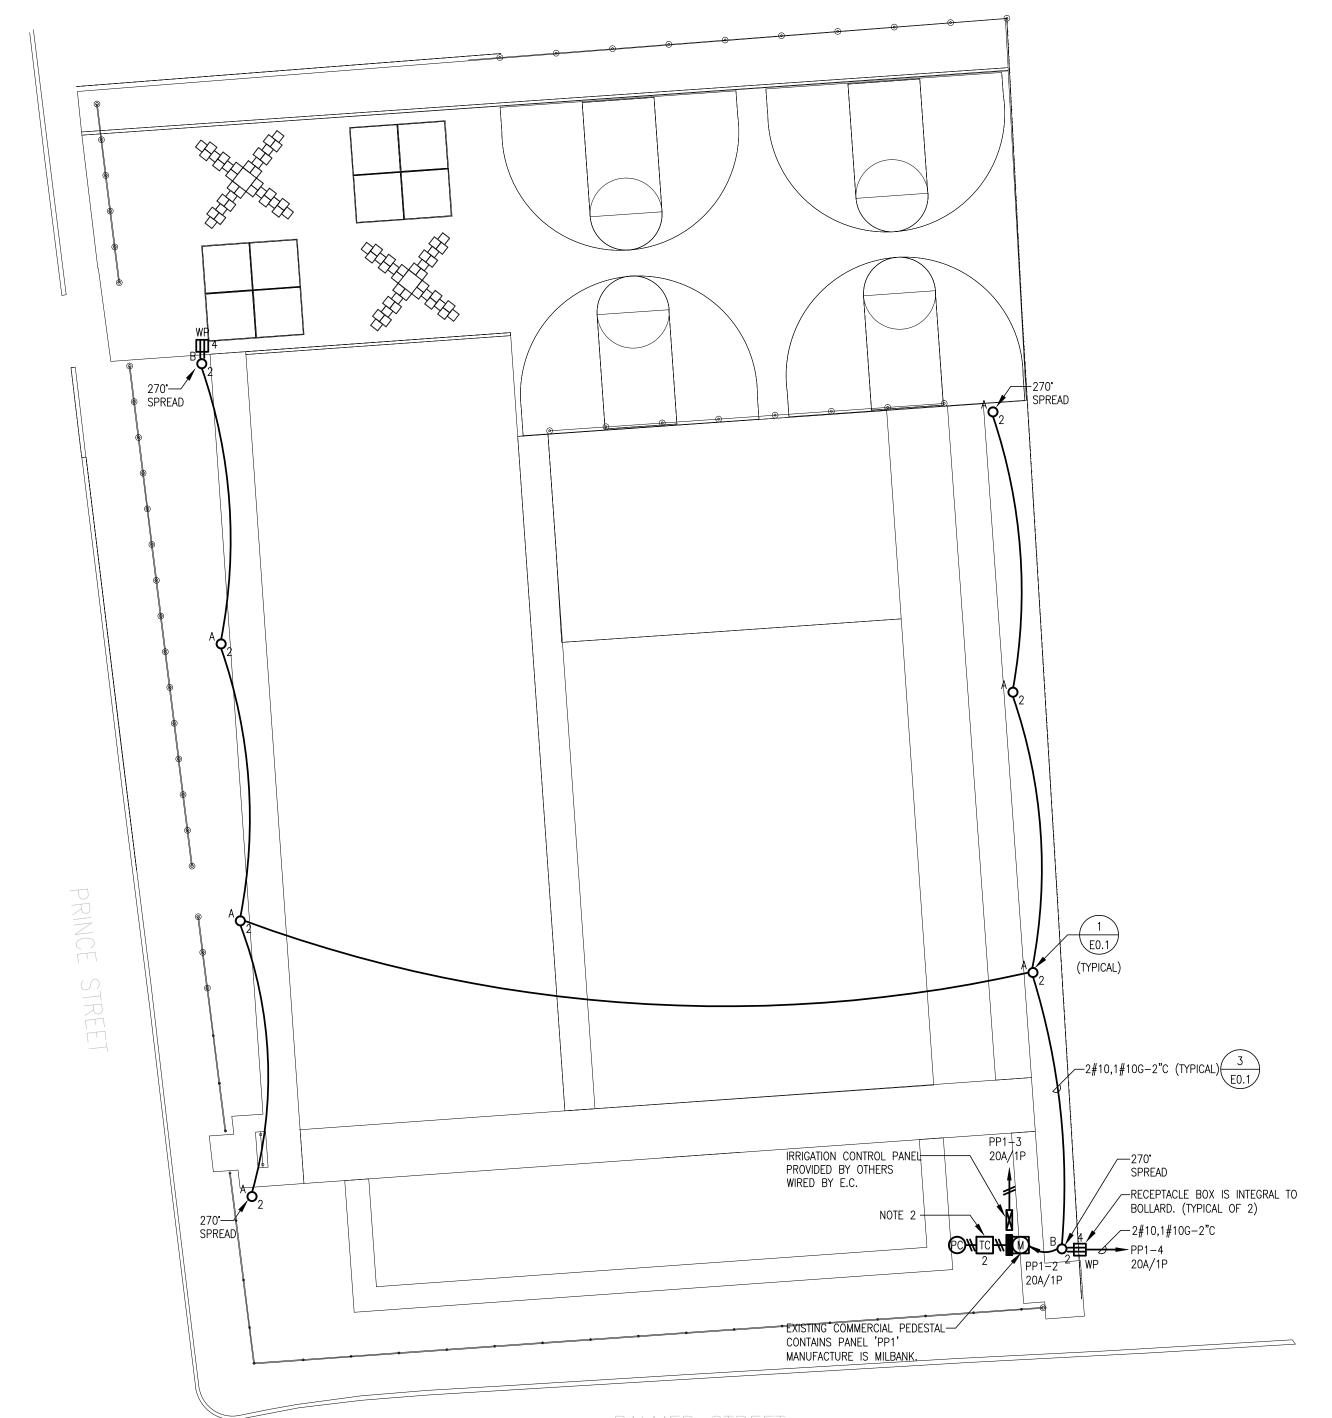

Existing conditions and topography data are from surveys prepared by *North Shore Survey Corporation*, 14 Brown St, Salem, MA, June 6, 2014.
 Contractor shall verify location of any existing utilities and services and provide protection during construction. Utilities damaged during construction shall be repaired at contractors expense.

3. Contractor shall obtain permits for the work as required and comply with all

laws, ordinances, rules and regulations of the local jurisdiction, the state, and all

other authorities having jurisdiction.

4. Contractor shall leave site clean and orderly during construction process.
Remove from site all excess materials, soil, debris and equipment. Store materials only in an approved location.

5. Contractor to secure site with fence at end of each day's operations.

LIGHTING FIXTURE SCHEDULE										
FIXTURE		LAMF								
TYPE	DESCRIPTION	AND CATALOG NUMBER No.	WATTAGE	TYPE	VOLTAGE					
А	VANDAL RESISTANT ROUND BOLLARD, BLACK	KIM LIGHTING # VRB3/LED 15L3KUV-BL	19	LED	120					
В	VANDAL RESISTANT ROUND BOLLARD, BLACK, GROUND FAULT RECEPTACLE	KIM LIGHTING # VRB3/LED 15L3KUV/BL/DR-GFI	19	LED	120					

- 1. PROVIDE (4) BOLLARDS WITH 270° SPREAD; ALL OTHERS SHALL BE TYPE 3, 180° SPREAD.
- 2. EC SHALL PROVIDE TIME CLOCK, CONNECT TO CIRCUIT NO. 2. MOUNT TO SIDE OF PANEL PP1. PROVIDE NECESSARY KNOCK OUT ON SIDE OF PANEL. 2#12, 1#12G-1/2" NIPPLE TO POWER THE TIME CLOCK AND PHOTOCELL.

	EXIST	ING I	PANEL 'F	P1'	, 60	AMP	, 120	0/24	10 V	OLT,	1 Ø	, 3 V	WIRE AND GROUND	
	INTERRUPTING CAPACITY: 10,000 AMPS RMS SYM MAIN: 60A MCB MOUNTING: NEMA 3R ENCLOSURE													
	LOAD	DESCRI	KVA I	LOAD B	CB/ PHASE	CIRC NO.	PH	CIRC NO.	CB/ PHASE	KVA I	OAD B	LOAD DESCRIPTION		
	EXISTING SPI			20	1	Α	2	20	0.15		SITE LIGHTING / TIME CLOCK	*		
*	IRRIGATION CONTROLS					20	3	В	4	20			RECEPTACLES	*
	SPACE					5	Α	6				SPACE		
0.00 0.00 SUBTOTALS 0.15 0.00										]				
	PHASE A 0.15 KVA TOTAL LOAD 0.15 K							KVA			OPTIONS:			
	PHASE B 0.00 KVA													
	SECTION 1													


* CONTRACTOR SHALL USE EXISTING BREAKER TO FEED LOAD AS INDICATED



MARY JANE LEE PARK PHASE II

Palmer St Salem, MA 01970

BID SET

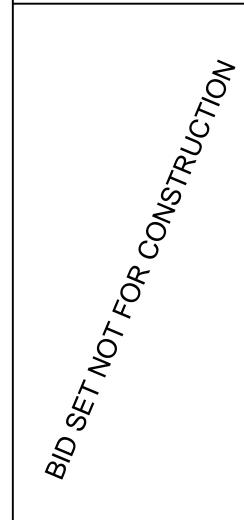

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JULY 20, 2016

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ELECTRICAL SITE PLAN

E1.0