Salem Fire Department - Bathroom Renovations

48 Lafayette St, Salem, MA 01970

IFB Project # 24-23-FIR

Owner:

Architect:

Salem Fire Department 48 Lafayette Salem, MA 01970 Phone: 978-744-1235 Seger Architects, Inc. 83 North Street Salem, MA 01970 Phone: 978-744-0208

SHEET DESCRIPTION Architectural COVER A-0.1 NOTE & SCHEDULES D-1.1 DEMO PLANS A-1.1 FLOOR PLANS A-1.2 REFLECTED CEILING PLANS A-2.1 ENLARGED ELEVATIONS

PROJECT INFORMATION

PROJECT: SALEM DEPT. BATHROOM REMODEL

LOCATION: 48 LAFAYETTE STREET, SALEM, MA 01970

EXISTING BUILDING: FIRE STATION

DESCRIPTION OF WORK: REMODEL OF EXISTING 1ST FLOOR
W. BATHROOM INTO ADA ACCESSIBLE

UNISEX BATHROOM

REMODEL OF EXISTING 2ND FLOOR
W. BATHROOM TO INCLUDE SHOWER &

_OCKERS

SYMBOLS ELEVATION KEY SHEET NUMBER BUILDING SECTION KEY SHEET NUMBER DETAIL NUMBER SHEET NUMBER DETAIL NUMBER DETAIL NUMBER The partition type REVISION # SYMBOL ELEVATION TARGET RECESSED FIRE EXTINGUISHER CABINET

GENERAL NOTES

- 1. These documents are the property of the architect and shall not be copied, duplicated, altered, modified or revised in any way without the expressed written approval of the architect.
- 2. To the best of the architects' knowledge these construction documents are in conformance with the requirements of the building authorities having jurisdiction over this type of construction and occupancy.
- 3. It is the intent of the architect to delineate these documents as accurate as possible for the purpose of graphic representation. Do not "scale" these documents. The dimensions shown are to take precedence over scaling the documents. The general contractor shall take full responsibility for any incorrect work and any repair of said work as a result of scaling the documents.
- 4. All work performed by the general contractor shall comply and conform with local and state building codes, ordinances and regulations, along with all other authorities having jurisdiction. The general contractor is responsible to be aware of these requirements and governing regulations.
- 5. The general contractor shall thoroughly review and become familiar with these documents. Upon review, the general contractor shall document and notify the architect of any errors, omissions, discrepancies and / or inconsistencies prior to the start of any portion of the proposed work. The architect shall review the proposed corrections after the receipt of notification. The discovery of discrepancies and / or conflicts after the start of work shall be the full responsibility of the general contractor to repair or replace.
- 6. The general contractor shall be responsible for the correction of any errors, omissions, discrepancies and / or inconsistencies which have not been brought to the architects' attention.
- 7. The general contractor shall accept the premises as is, in its current state. The owner shall assume no responsibility for the condition of the existing site, and its contents, at the time of bidding or thereafter.
- 8. The general contractor shall field verify all existing site conditions, along with dimensions and elevations, prior to the start of any portion of the work. All findings, discrepancies and concerns shall be brought to the owners' attention in written format.
- 9. The general contractor shall be responsible for all work and materials represented on these documents including the work and materials furnished by subcontractors and vendors.
- 10. Deviations from these documents in the construction phase shall be reviewed by the architect and the owner prior to the start of work in question. Any deviations from these documents without prior review, shall be the sole responsibility of the general contractor.
- 11. It is the sole responsibility of the general contractor to determine erection procedure, means and methods and sequence of construction.
- 12. The general contractor is responsible to produce and comply with an approved construction schedule acceptable to the owner's expectations.
- 13. Shop drawing review and distribution, along with product submittals, requested in the construction documents, shall be the sole responsibility of the general contractor, unless directed otherwise under a separate agreement.
- 14. The architect shall not accept, or review any request for shop drawing review and / or stamp without the review and stamp of the general contractor clearly shown on the documents.
- 15. Coordination: It shall be the responsibility of the contractor to check and coordinate all the drawings before fabrication and/or installation of any work. The contractor shall immediately notify the architect and engineers of any discrepancies or errors.
- 16. Legend: All symbols and abbreviations used on the drawings are considered construction standards. If the contractor has any questions regarding the same or their exact meaning, the architect and engineer shall be notified in writing for clarification.
- 17. Precedence: Dimensions shall have precedence over scale. larger scale drawings have precedence over smaller scale drawinas.

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PROJECT ARCHITECT

SEAL

SALEM FIRE
DEPARTMENT
48 Lafayette St,
Salem, MA, 01970

PROJECT INFORMATION

CONSULTANT INFORMATION

OWNER INFORMATION

1	Bid Revision 1	10.24.23			
No.	Description	Date			
PF	PROJECT REVISIONS				

Job No.: 2023-005

Date: October 4, 2023

Scale: As Noted

Designed By: JAS

Drawn By: SL

Checked By: JAS

Approved By: JAS

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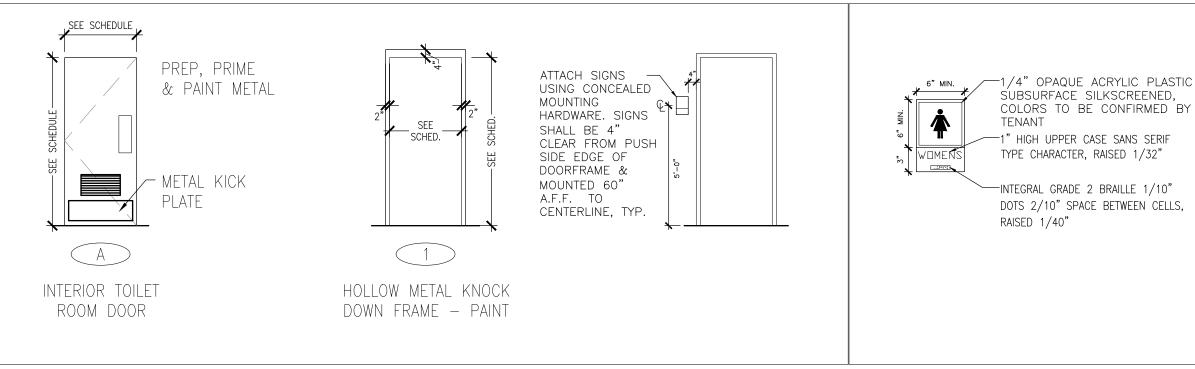
Cover

SHEET NAME

Cover

CONSTRUCTION NOTES

- ALL WORK SHALL CONFORM TO LATEST EDITION OF STATE AND ALL OTHER APPLICABLE CODES AND REGULATIONS.
- BEFORE STARTING FRAMING OF PARTITIONS, THE GENERAL CONTRACTOR SHOULD LAY OUT THE PARTITIONS ON THE FLOOR AND CONTACT THE ARCHITECT (MIN. 24 HOURS PRIOR) TO MAKE A FIELD VISIT AND VERIFY THE LAYOUT. WORK THAT PROCEEDS WITHOUT VERIFICATION IS AT THE CONTRACTOR'S OWN RISK. COSTS OF ANY CHANGES REQUIRED BY THE ARCHITECT OF SAID WORK SHALL BE SOLELY BORNE BY THE CONTRACTOR.
- ALL CONFLICTS AND ITEMS FOR CLARIFICATION SHALL BE BROUGHT TO THE ARCHITECT'S ATTENTION PRIOR TO AFFECTING WORK IN THAT AREA.
- IF VARIANCE FROM THE EXISTING DRAWING OCCURS, NOTIFY THE ARCHITECT PRIOR TO COMMENCING ANY RELATED WORK.
- THE DRAWINGS DEPICT ONLY GENERALLY THE EXISTING CONDITION. THE CONTRACTOR SHALL BE RESPONSIBLE FOR EXACT QUANTITY TAKEOFFS BASED ON FIELD OBSERVATIONS.
- THE GENERAL CONTRACTOR SHALL COORDINATE THE LOCATION OF REQUIRED BLOCKING IN WALLS TO RECEIVE SHELVING, CABINETS, TELEVISIONS, MAJOR ARTWORK, COAT RODS, OR OTHER WALL MOUNTED APPARATUS, WHERE CONCEALED WOOD BLOCKING OR FRAMING IS REQUIRED, CONTRACTOR SHALL ONLY USE FIRE-RETARDANT TREATED WOOD.
- WHERE FIRE RATED AND FULL HEIGHT PARTITIONS ARE PENETRATED BY STRUCTURAL MEMBERS, DUCTWORK, PIPING, AND/OR CONDUIT, THE WALL BOARD SHALL BE SCRIBED TO FIT TIGHT AGAINST THE PENETRATING ITEM, AND CAULKED WITH THE APPROPRIATE SEALANT. COORDINATE WITH MEP WORK AND DETAILS.
- THE GENERAL CONTRACTOR SHALL COORDINATE WITH DOOR AND GWB SUBS FOR FIT OF NEW FRAMES AT PARTITIONS SO NO GAP OCCURS — CONTRACTOR TO VERIFY THROAT SIZE.
- REFER TO SPECIFICATIONS FOR DEMOLITION REQUIREMENTS.




Door Type








DOOR SCHEDULE										
Щ	DOOR						FRAME			REMARKS
#	WIDTH	HEIGHT	TYPE	MATERIAL	FINISH TYPE MATERIAL	FINISH	SET	KEMAKKS		
FIRST FLOOR										
001	3'-0"	6'-8"	А	METAL	PAINT	А		PAINT	EXIST	W/ 20"X12" LOUVER

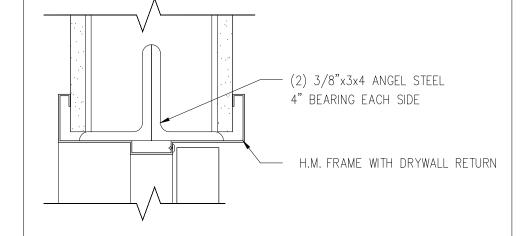


DOOR HEADER DETAIL

WALL PARTITION SCHEDULE

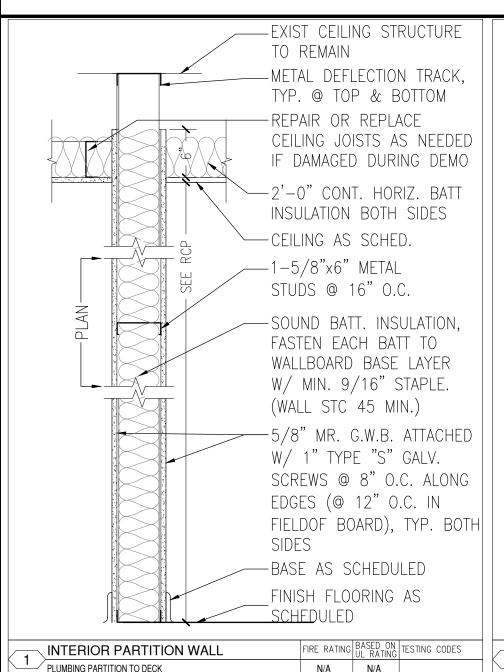

NOTE: REFER TO COLD FORMED STEEL MANUFACTURER FOR INSTALLATION INSTRUCTIONS AND REQUIREMENTS FOR ALL

LIGHT GAGE METAL FRAMING

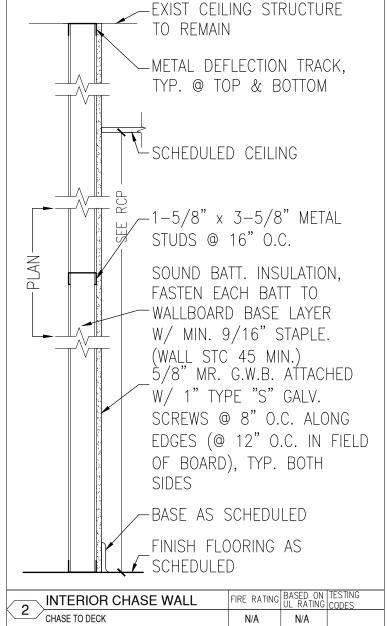

FINISH SCHEDULE LOOR FINISHES BASES WALL FINISHES

COLOR: T.B.D. F2- CARPET TILE (PROVIDED BY SFD)

F1 - POURED EPOXY B1 - POURED EPOXY COVE BASE, COLOR TO MATCH FLOOR B2 - RUBBER COVE

BASE

W1 - PTD GWB W2 - PTD MR GWB W3 - NOT USED W4 - EXIST WALL PTD

CEILING FINISHES C1 - PAINTED MOISTURE RESISTANT GWB C2 - PATCH & PAINT ACOUSTIC TILE SYSTEM MATCH EXIST.

NOTE:

ROOM#	ROOM NAME / TYPE FLOOR FINISH BASE WALL FINISH CEILING FINISH		POOM NAME / IVDE BASE WALLENISH		ME/IVDE BASE WALLEINISH			CEILING HEIGHT	REMARKS
FIRST FLOOR									
101	UNISEX	F1	B1	W2	C1	±8'-2"			
102	OFFICE	F2	B2	W1/W4	C2	±8'-6"	PAINT EXISTING WALLS		
SECOND FLOOR									
201	WOMEN	F1	B1	W2	C1	±8'-0"			
202	OFFICE	EX	EX	W1/W4	C2	±8'-4"	PAINT EXISTING WALLS		

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SEAL

SALEM FIRE DEPARTMENT 48 Lafayette St, Salem, MA, 01970

PROJECT INFORMATION

CONSULTANT INFORMATION

OWNER INFORMATION

Date Description PROJECT REVISIONS

2023-005 October 4, 2023 As Noted Drawn By: Checked By: JAS Approved By: Copyright © by Seger Architects, Inc. All rights reserved.

NOTES & **SCHEDULES**

SHEET NAME

A-0.1

SHEET NO.


10-04-2023 -BID SET (NOT FOR CONSTRUCTION)

DEMOLITION NOTES

- 1. ALL DEMOLITION WORK TO BE DONE AS PER THE DRAWINGS AND ASSOCIATED NOTES. ANY WORK COMPLETED THAT CONTRADICTS THE DRAWINGS AND NOTES WILL BE SOLELY BORNE BY THE DEMOLITION CONTRACTOR
- 2. REMOVE AND LEGALLY DISPOSE OF ITEMS EXCEPT THOSE INDICATED TO BE REINSTALLED, SALVAGED, OR TO REMAIN THE OWNER'S PROPERTY.
- 3. EXISTING TO REMAIN: PROTECT CONSTRUCTION INDICATED TO REMAIN AGAINST DAMAGE AND SOILING DURING SELECTIVE DEMOLITION.
- 4. EXCEPT FOR ITEMS OR MATERIALS INDICATED TO BE REUSED, SALVAGED, REINSTALLED, OR OTHERWISE INDICATED TO REMAIN THE OWNER'S PROPERTY, DEMOLISHED MATERIALS SHALL BECOME THE CONTRACTOR'S PROPERTY AND SHALL BE REMOVED FROM THE SITE WITH FURTHER DISPOSITION AT THE CONTRACTOR'S OPTION.
- 5. WHEN DISPOSING OF MATERIAL, SEPARATE CONTENTS INTO RECYCLE CONTAINERS PRIOR TO DELIVERY TO LANDFILL.
- 6. CONTRACTOR SHALL VERIFY THAT UTILITIES HAVE BEEN DISCONNECTED AND CAPPED.
- 7. COORDINATE WITH ELECTRICAL SUBCONTRACTOR WITH RESPECT TO ELECTRICAL DEMOLITION AND DE-ENERGIZING OF PARTICULAR PORTIONS OF THE BUILDING.
- 8. INVENTORY AND RECORD THE CONDITION OF ITEMS TO BE REMOVED AND REINSTALLED, AND ITEMS TO BE REMOVED AND SALVAGED.
- 9. IF UNANTICIPATED EXISTING BUILDING ELEMENTS THAT CONFLICT WITH THE INTENDED FUNCTION OR DESIGN ARE ENCOUNTERED, INVESTIGATE AND MEASURE THE NATURE AND EXTENT OF THE CONFLICT. PROMPTLY SUBMIT A WRITTEN REPORT TO THE ARCHITECT.
- 10. SURVEY THE CONDITION OF THE BUILDING TO DETERMINE WHETHER REMOVING ANY ELEMENT MIGHT RESULT IN STRUCTURAL DEFICIENCY OR UNPLANNED COLLAPSE OF ANY PORTION OF THE STRUCTURE OR ADJACENT STRUCTURES DURING SELECTIVE DEMOLITION. G.C. IS RESPONSIBLE FOR SHORING IF REQUIRED.
- 11. MAINTAIN EXISTING UTILITIES THAT ARE TO REMAIN IN SERVICE AND PROTECT THEM AGAINST DAMAGE DURING SELECTIVE DEMOLITION OPERATIONS.
- 12. UTILITY REQUIREMENTS: COORDINATE WITH MECHANICAL AND ELECTRICAL WORK FOR SHUTTING OFF, DISCONNECTING, REMOVING, AND SEALING OR CAPPING UTILITY SERVICES. DO NOT START SELECTIVE DEMOLITION WORK UNTIL UTILITY DISCONNECTING AND SEALING HAVE BEEN COMPLETED AND VERIFIED IN WRITING.
- 13. CLEAN ADJACENT STRUCTURES AND IMPROVEMENTS OF DUST, DIRT, AND DEBRIS CAUSED BY SELECTIVE DEMOLITION OPERATIONS. RETURN ADJACENT AREAS TO CONDITION EXISTING BEFORE START OF SELECTIVE DEMOLITION.
- 14. ALL DEMOLITION ACTIVITIES WILL BE PERFORMED IN ACCORDANCE WITH APPLICABLE FEDERAL, STATE, AND LOCAL ENVIRONMENTAL REGULATIONS.
- 15. NEATLY SAW CUT OPENINGS AND HOLES PLUMB, SQUARE, AND TRUE TO DIMENSIONS REQUIRED. USE CUTTING METHODS LEAST LIKELY TO DAMAGE CONSTRUCTION TO REMAIN OR ADJOINING CONSTRUCTION. TO MINIMIZE DISTURBANCE OF ADJACENT SURFACES, USE HAND OR SMALL POWER TOOLS DESIGNED FOR SAWING OR GRINDING, NOT HAMMERING AND CHOPPING. TEMPORARILY COVER OPENINGS TO REMAIN.
- 16. PROMPTLY PATCH AND REPAIR HOLES AND DAMAGED SURFACES CAUSED TO ADJACENT CONSTRUCTION BY SELECTIVE DEMOLITION OPERATIONS.
- 17. WHERE REPAIRS TO EXISTING SURFACES ARE REQUIRED, PATCH TO PRODUCE SURFACES SUITABLE FOR NEW MATERIALS.
- 18. RESTORE EXPOSED FINISHES OF PATCHED AREAS AND EXTEND FINISH RESTORATION INTO ADJOINING CONSTRUCTION TO REMAIN IN A MANNER THAT ELIMINATES EVIDENCE OF PATCHING AND REFINISHING.
- 19. EXCEPT WHERE OTHERWISE NOTED, TRANSPORT DEMOLISHED MATERIALS OFF OWNER'S PROPERTY AND LEGALLY DISPOSE OF THEM TO LANDFILL OR RECYCLING FACILITY PERMITTED TO ACCEPT TYPE OF WASTE.
- 20. SWEEP THE BUILDING BROOM CLEAN UPON COMPLETION OF SELECTIVE DEMOLITION OPERATION.

DEMOLITION KEY NOTES

- 1 REMOVE & DISPOSE OF DOOR & FRAME IN IT'S ENTIRETY
- 2 REMOVE & DISPOSE OF EXISTING WALL TILES & GWB IN IT'S ENTIRETY PREP WALLS FOR FINISHED PER SCHEDULE
- (3) REMOVE & DISPOSE OF EXISTING TROFFER LIGHT
- 4 REMOVE & DISPOSE OF EXISTING PLUMBING FIXTURES & VANITY
- 5 REMOVE & DISPOSE OF EXIST. CARPET, PREP FLOOR & INSTALL CARPET TILE (CARPET TILE WILL BE PROVIDED BY OWNER)
- (6) REMOVE & DISPOSE OF EXISTING CMU WALL
- 7 REMOVE & STORE EXIST. TOILET FOR FUTURE INSTALLATION.
- 8 REMOVE & DISPOSE OF EXISTING FLOOR & BASE TILE IN IT'S ENTIRETY, PREP FLOOR FOR FINISHED SCHEDULE

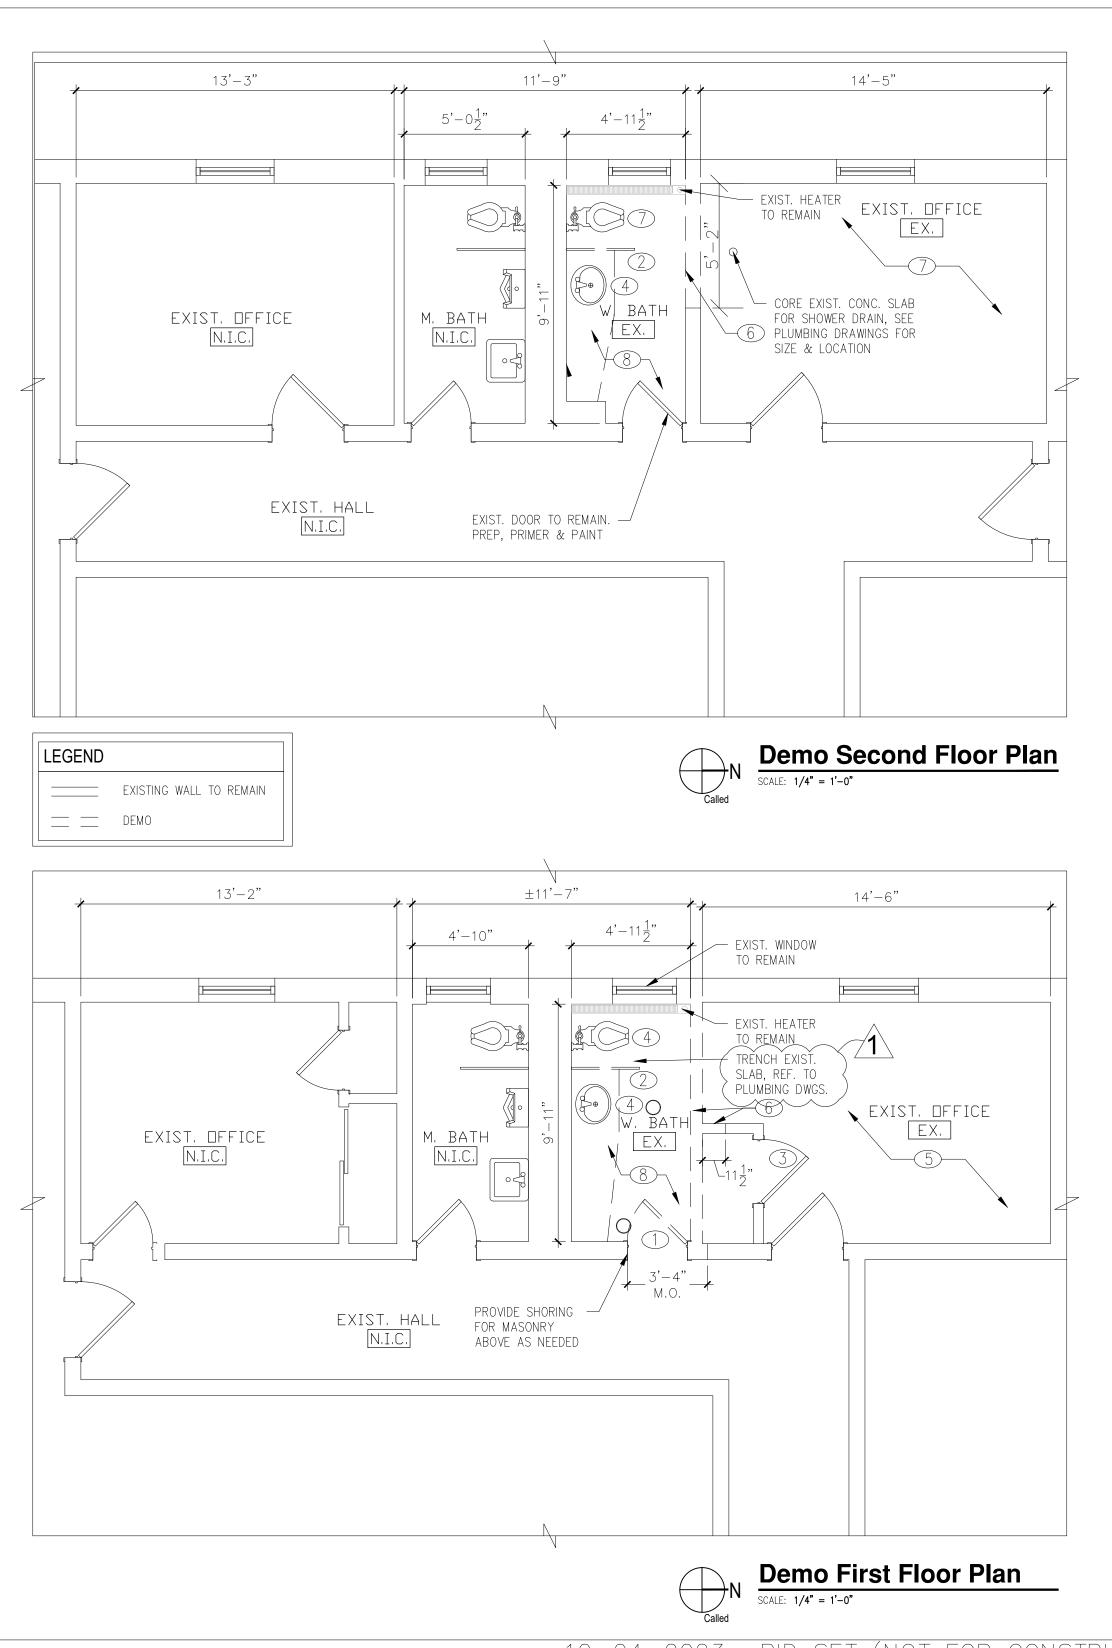

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1 Bid Revision 1 10.24.23

No. Description Date

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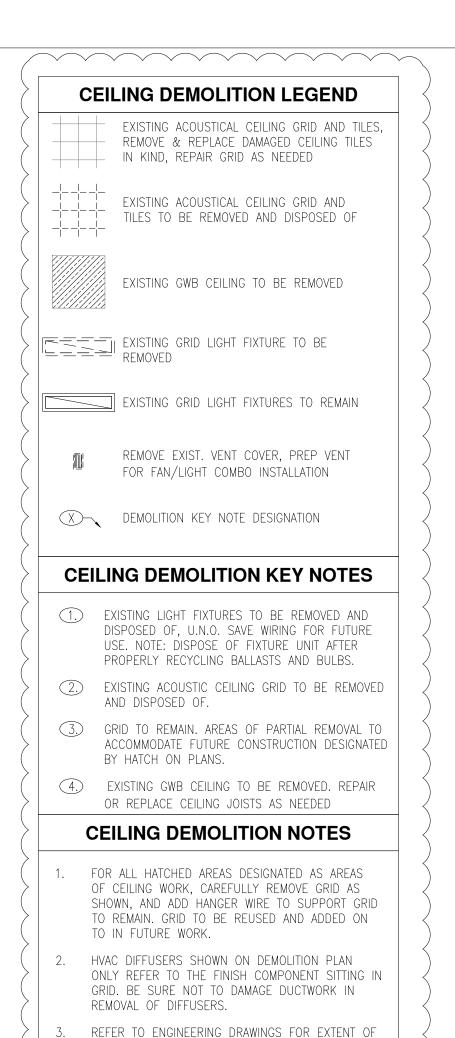
DEMOLITION

SHEET NAME

D-1.1

SHEET NO.

10-04-2023 -BID SET (NOT FOR CONSTRUCTION)



ELECTRICAL, HVAC, PLUMBING, AND SPRINKLER


WORK TO BE REMOVED OR RELOCATED. ANY INFORMATION SHOWN ON ARCHITECTURAL PLANS IS


USED AS APPROXIMATE REPRESENTATION FOR

REPAIR OR REPLACE CEILING JOISTS AS NEEDED

COORDINATION PURPOSES ONLY.

IF DAMAGED DURING DEMO

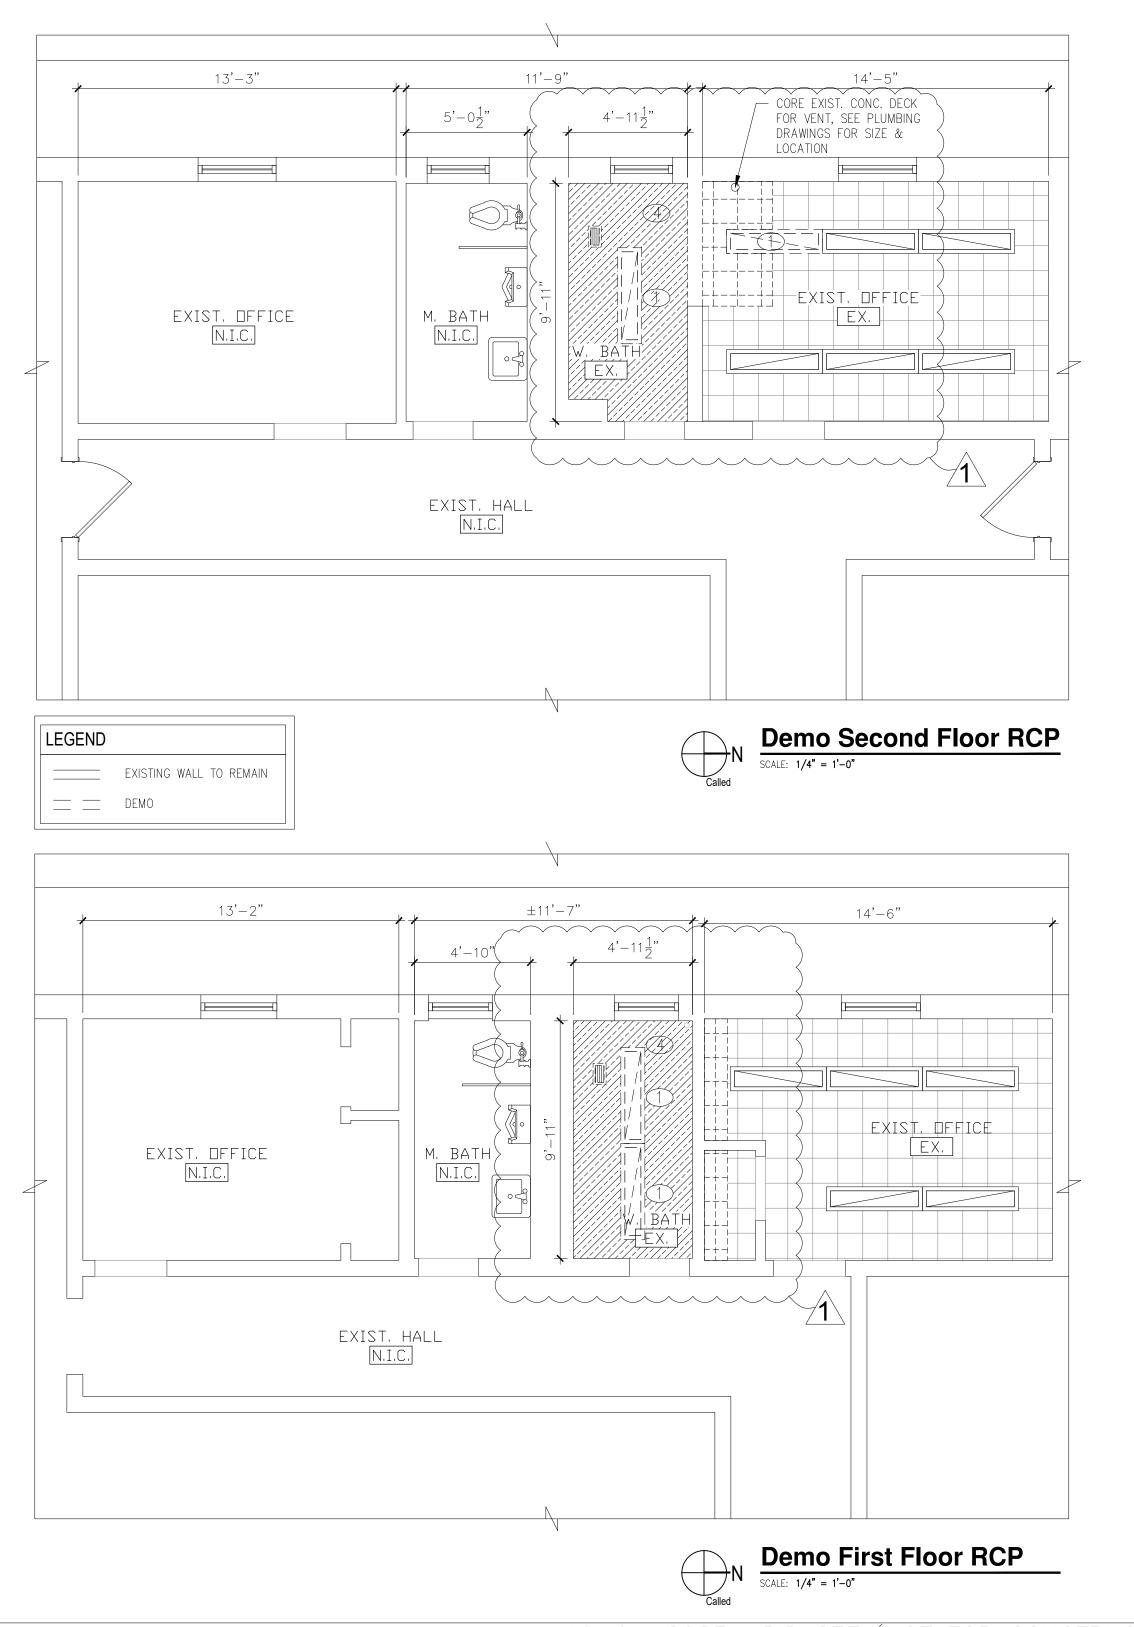


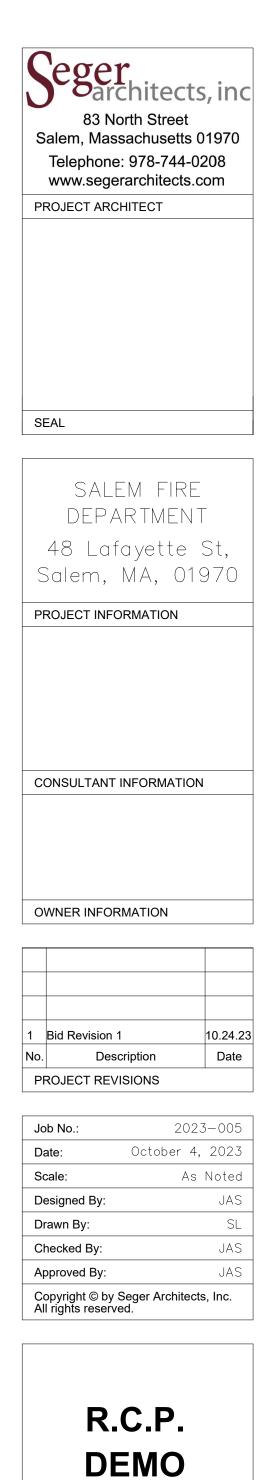


SHEET NO.

D-1.2


SHEET NAME

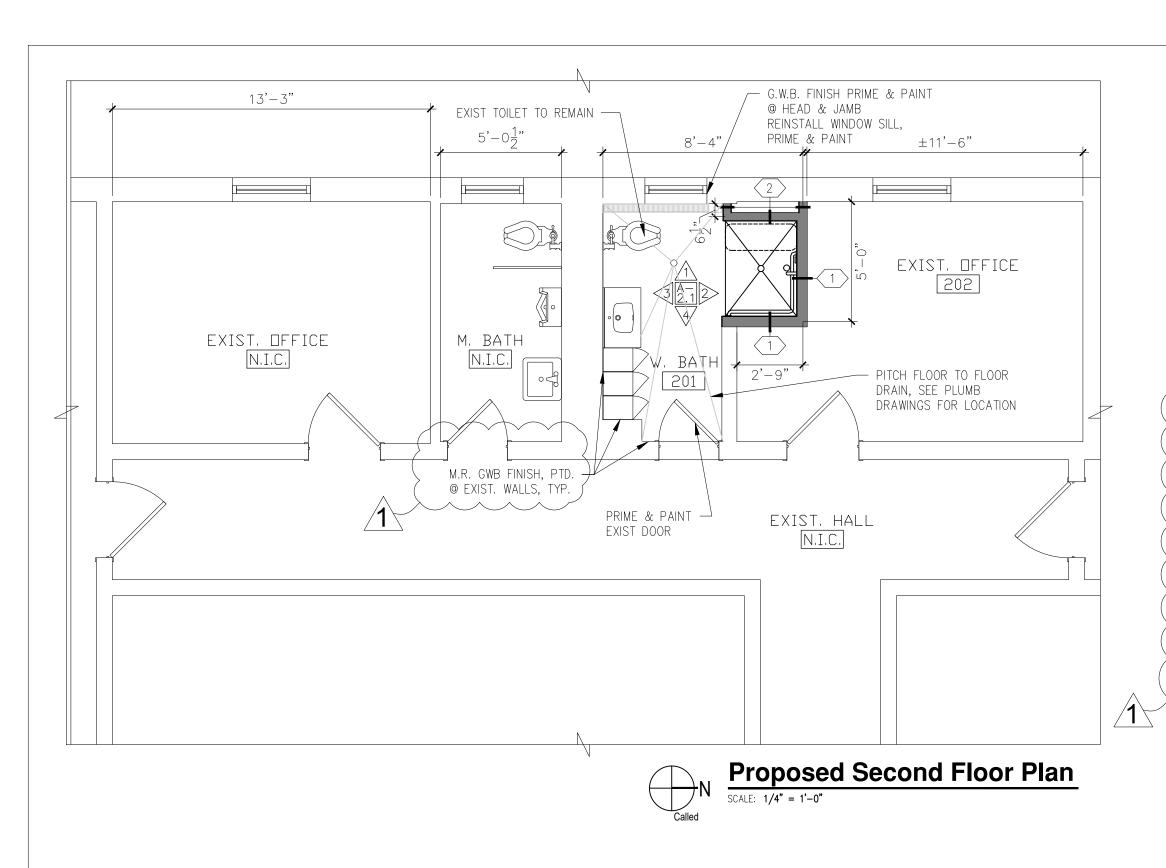

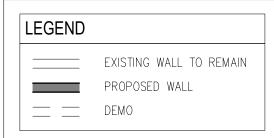

CONSTRUCTION NOTES

- 1. PATCH & REPAIR WALLS, FLOOR & CEILING AS REQD.
- 2. REPLACE CEILING EXHAUST FAN AS SCHEDULED OR EQUAL
- 3. PROVIDE POWER & SWITCHES AS NEED REQD.
- REPLACE ALL LIGHT FIXTURE AS SCHEDULED
- PREPARE CEILING FOR FINISH PER SCHEDULE.

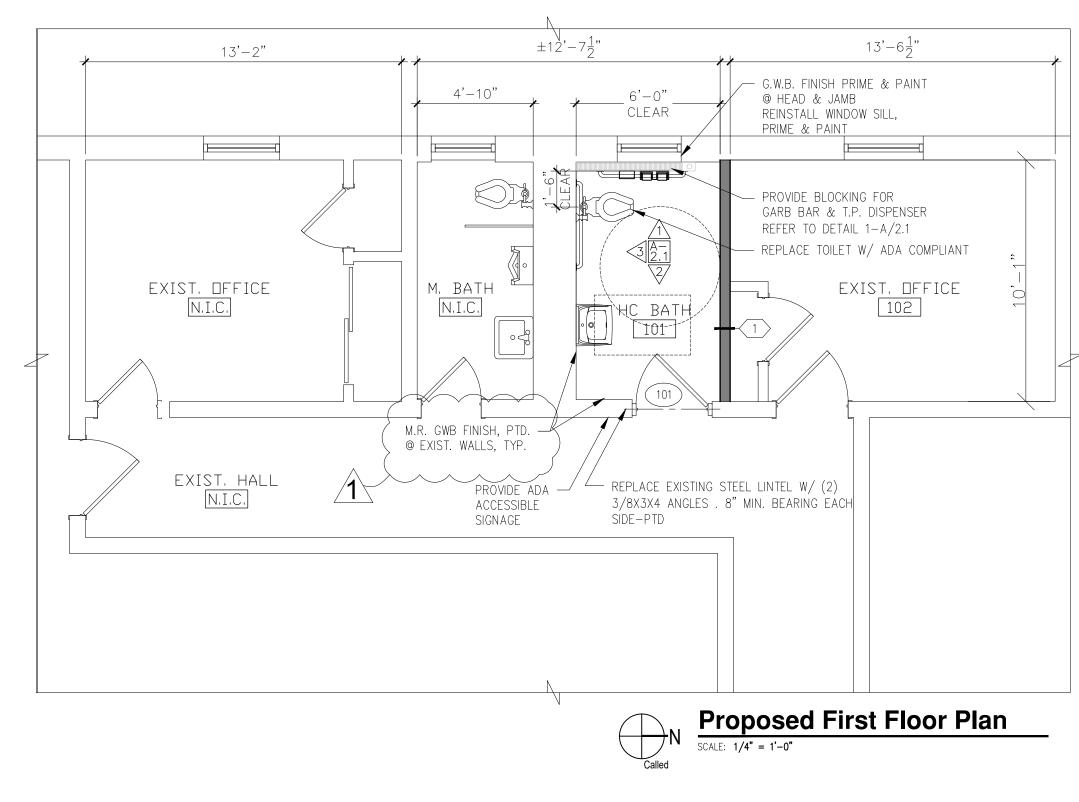

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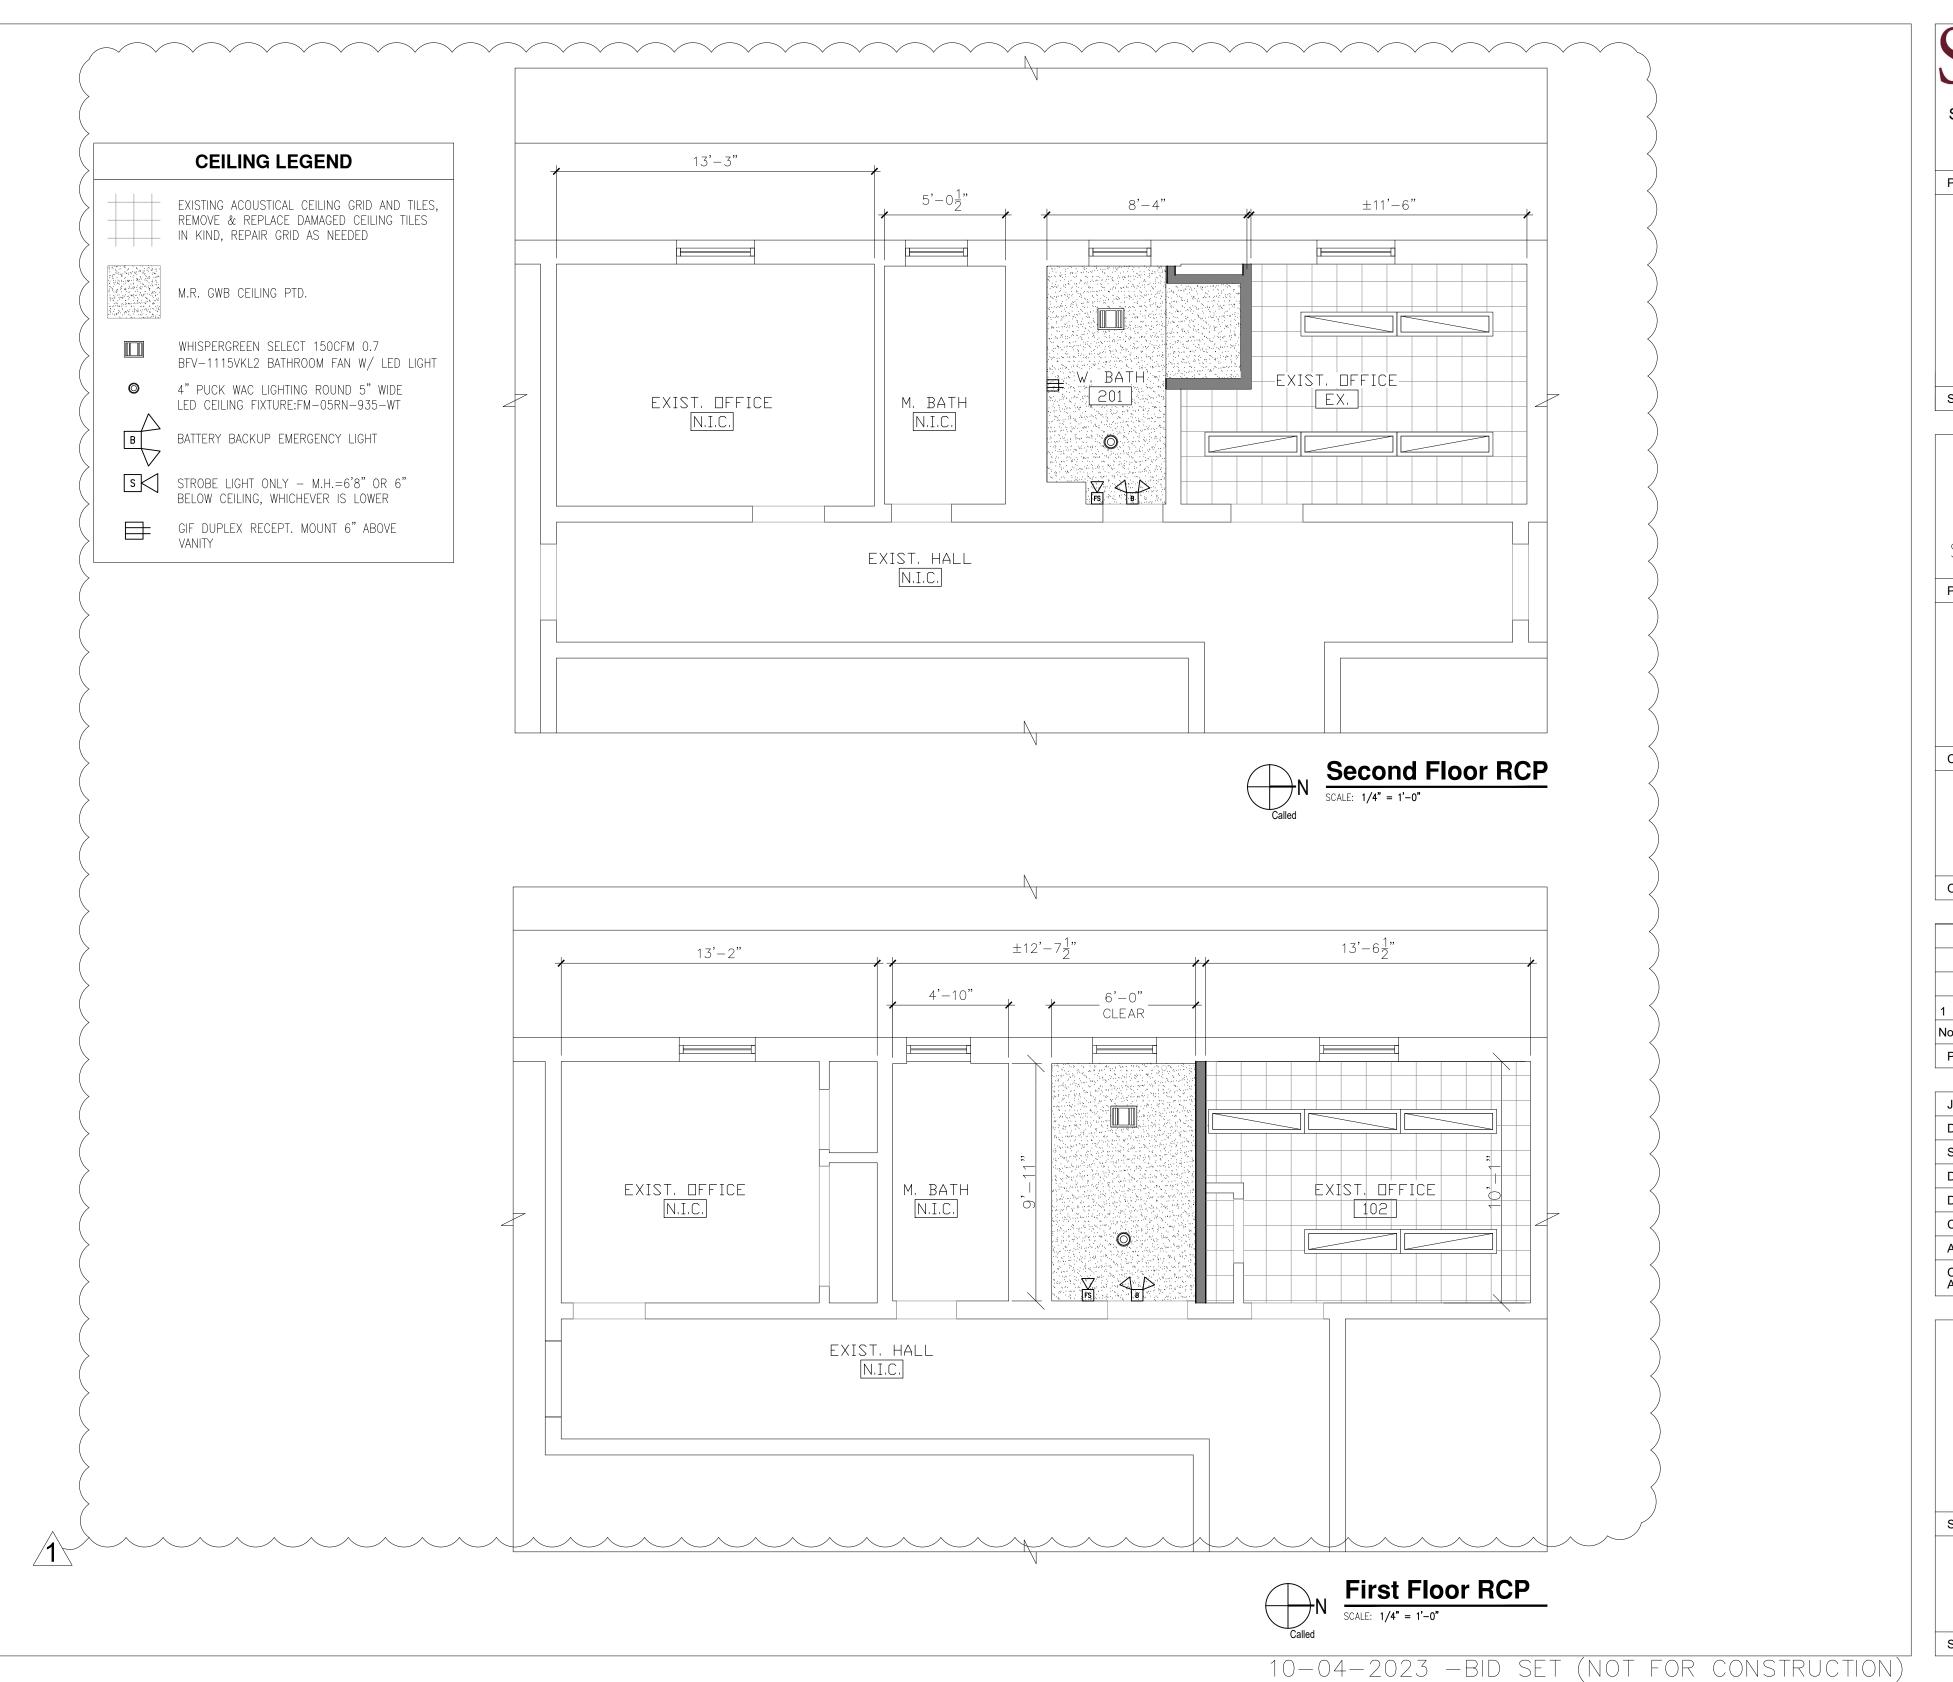
PROJECT REVISIONS

Job No.:	2023-005		
Date:	October 4, 2023		
Scale:	As Noted		
Designed By:	JAS		
Drawn By:	SL		
Checked By:	JAS		
Approved By:	JAS		
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FLOOR PLANS

SHEET NAME

A-1.1



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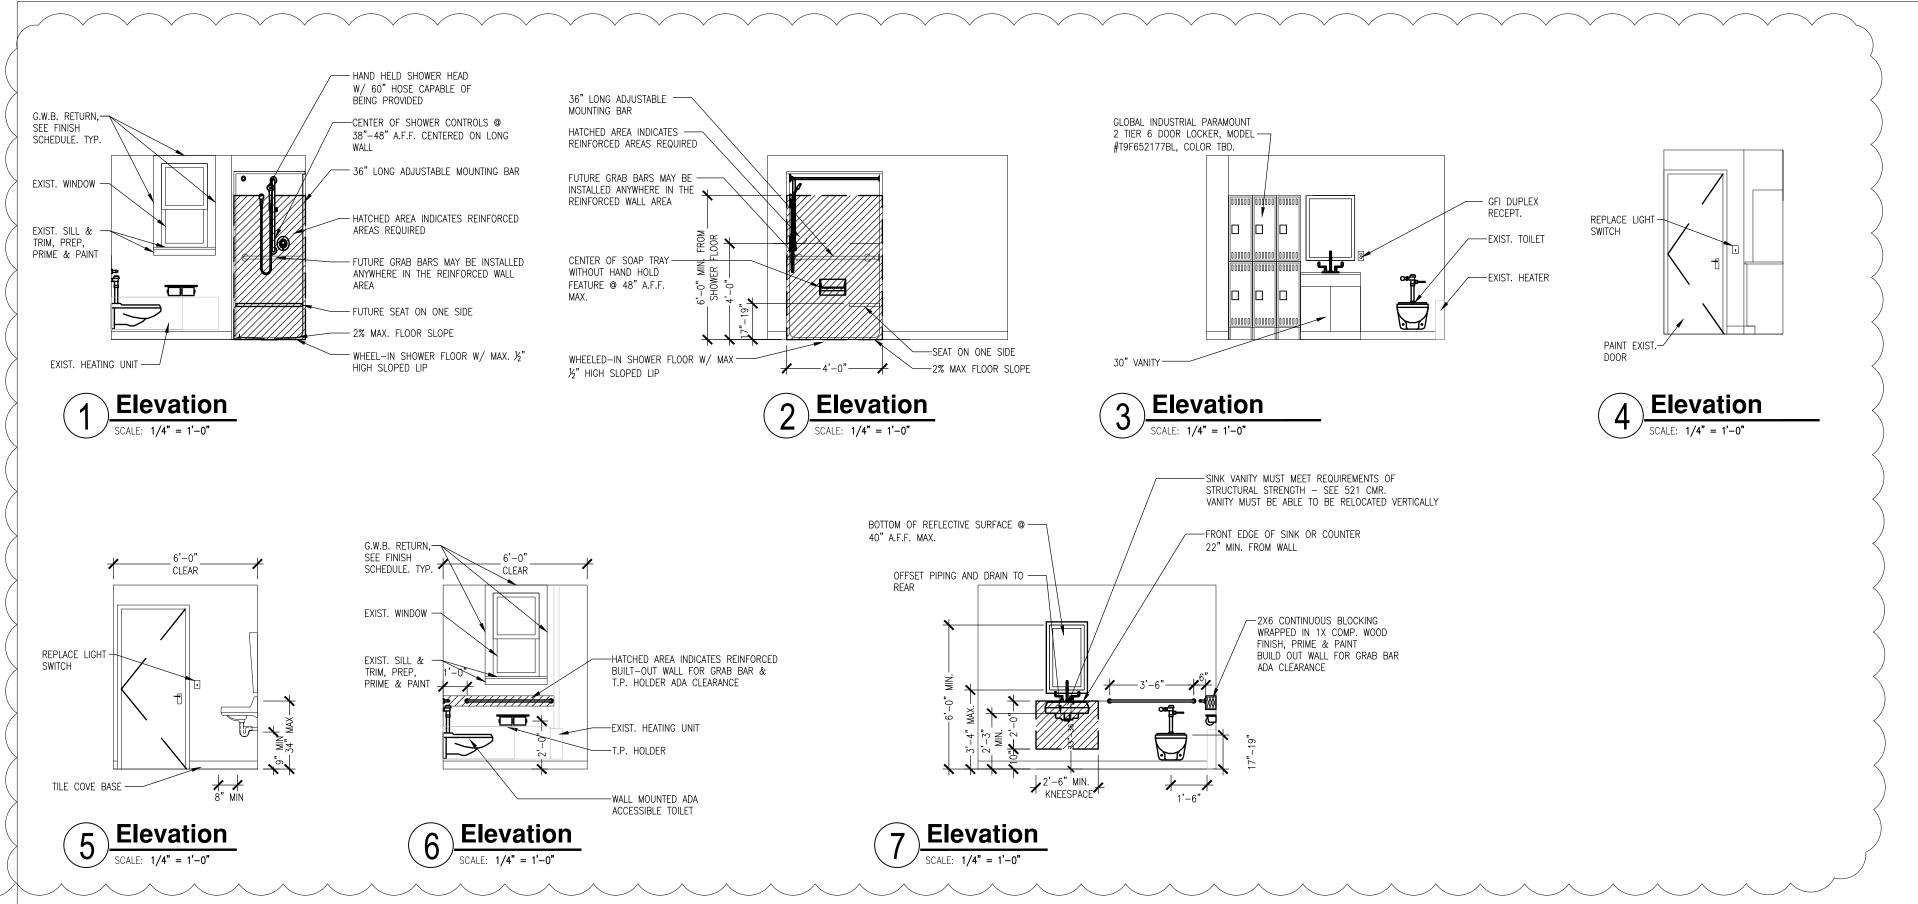
Approved By: JAS

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R.C.P.

SHEET NAME

A-1.2







NOTES:

11) COMPONENTS LISTED BELOW TO SERVE AS BASIS OF DESIGN. REFER TO SPECIFICATIONS.

TAG		MANUFACTURER	FINISH / PART	
	COMPONENT	(OR EQUAL)	NUMBER	NOTES
1	STAINLESS STEEL CHANNEL FRAME MIRROR	BOBRICK	B-165-XXXX	24" WIDE x 36" TALL 40" MAX. ABOVE FINISHED FLOOR, CENTERED AS SHOWN ON ELEVATIONS.
2	SOAP DISPENSER	BOBRICK	B-824	HANDS-FREE SOAP DISPENSER, TOP FILL, LIQUID SOAP
3	ACCESSIBLE TOILET GRAB BARS	BOBRICK	B-6806.99x42	2X 42", ENSURE GRAB BARS MEET ALL MAAB REQUIREMENTS
4	PAPER TOWEL DISPENSER	BOBRICK	B-2974	MOUNTED WITH OPERABLE PORTION 48" A.F.F. MAX.
5	TOILET PAPER DISPENSER	BOBRICK	B-540	CENTER OF ROLL MOUNTED 24" A.F.F., 7"-9" HORIZONTALLY FROM FRONT OF TOILET
6	TRASH RECEPTACLE	BOBRICK	B-2260	OPEN-TOP, NO COVER (B-2250 FOR COVER) MOUNTED UNDER EACH TRASH CHUTE
7	COAT HOOK W/ BUMPER	BOBRICK	B-212	1 PER TOILET STALL ON BACK OF DOOR, MOUNTED AT 54" A.F.F. MAX. IN ACCESSIBLE STALLS
8	SEE PLUMBING DWGS	_	_	SEE ENGINEERING SPECIFICATIONS
9	SEE PLUMBING DWGS	_	_	SEE ENGINEERING SPECIFICATIONS

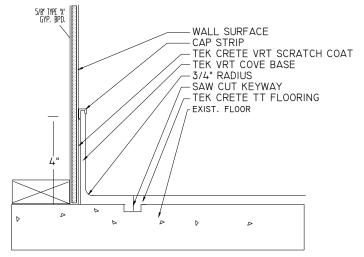

8 Cove Base Detail
SCALE: N.T.S.

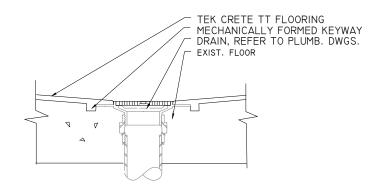

9 Floor Drain Detail scale: N.T.S.

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ENLARGED
PLANS &
ELEV.

SHEET NAME

A-2.1

PIPING SPECIFICATIONS FOR PLUMBING WORK ONLY								
PIPING MATERIAL COMMENTS								
ABOVE GROUND SANITARY+WASTE+ VENT PIPING	CAST IRON, NO HUB W/ CLAMPS	1. USED FOR ALL COMMERCIAL SPACES						
BELOW GROUND SANITARY+WASTE+VENT PIPING	CAST IRON, BELL & SPIGOT w/ PUSH ON NEOPRENE GASKETS	1. USED FOR ALL COMMERCIAL SPACES						
DOMESTIC WATER (HOT&COLD)	TYPE L COPPER WITH SOLDER JOINTS OR PRO PRESS JOINTS	1. USE FOR ALL COMMERCIAL SPACES						

SCHEDULE OF FLOOR DRAINS, FLOOR CLEANOUTS, HOSE BIBBS

DESIGNATION	LOCATION	MANUFACTURER	MODEL NO	COMMENTS
FD-A	TOILET ROOMS	WATTS	FD-100-A5	1. PROVIDE TRAP PRIMER & ASSOCIATED TRAP PRIMER WATER PIPING
FC0	SEE PLANS	WATTS	CO 1200-RX ROUND STAINLESS STEEL	REFER TO PLAN FOR LOCATION OF FCO ALL FCO LOCATIONS TO BE APPROVED BY OWNER
HOSE BIBB (HB)	SEE-PLANS	WOODFORD	37-HD-1 34" BALL VALVE W/ VB & CAP CHAIN	

DEMOLITION NOTES

- 1. ALL NEW WORK IS DRAWN HEAVY
- 2. EXISTING PIPING AND FIXTURE TO REMAIN ARE DRAWN LIGHT.
- THE LOCATIONS OF THE PIPING, FIXTURES, ELEVATIONS, ETC. HAVE BEEN TAKEN FROM THE BEST SOURCES AVAILABLE AND MUST BE VERIFIED IN THE FIELD PRIOR TO COMMENCING WORK IN RENOVATED AREAS.
- SINCE PORTIONS OF THE EXISTING BUILDING SHALL REMAIN IN OPERATION DURING CONSTRUCTION, THE PHASING REQUIREMENTS SHALL BE MET BY THIS SUB-CONTRACTOR AND ALL REQUIRED PIPES, VALVES, AND FITTINGS NECESSARY TO ACCOMPLISH SAME SHALL BE PROVIDED. COORDINATION OF THIS VERY IMPORTANT.
- RELOCATE ALL SOIL STACK AND VENT STACKS EXPOSED DUE TO DEMOLITION OF FIXTURES AND/OR PARTITIONS, WHEN STACKS ARE ACTIVE. RELOCATE AS DIRECTED BY ARCHITECT AND/OR ENGINEER. IT IS THE RESPONSIBILITY OF THIS SUB-CONTRACTOR TO KEEP ALL WASTE, VENT AND WATER RISERS ACTIVE DURING RELOCATION. ALL SHUT-DOWNS MUST BE APPROVED WITH OWNER AND ARCHITECT.
- DEBRIS REMOVAL FROM THE CONSTRUCTION SITE WILL BE COMPLETED BY A PREDETERMINED ROUTE AT PREDETERMINED TIMES. COORDINATE WITH THE HOSPITAL.
- REFER TO PLUMBING EQUIPMENT DETAILS FOR VALVE AND BYPASS LOCATIONS.
- EXISTING PLUMBING FIXTURES TO BE REMOVED SHALL HAVE ALL ASSOCIATED WASTE, VENT & WATER PIPING REMOVED BACK TO STACKS, MAINS AND OR RISERS.

PLUMBING LEGEND

SYMBOL		ABBREVIATION	DESCRIPTION
EXISTING	NEW	— Sor W	SOIL or WASTE PIPING
		= S or W	SOIL OF WASTE PIPING (AT FLOOR BELOW)
			, ,
		V	VENT PIPING
=======================================		== V	VENT PIPING (AT FLOOR BELOW)
		— CW	DOMESTIC COLD WATER PIPING
		— HW	DOMESTIC HOT WATER PIPING
G		G	NATURAL GAS
ıw	IW	— IW	INDIRECT WASTE
·	₩	_	BALL OR GATE VALVE
	Ø	— DV	DRAIN VALVE
-x - x - x - x -			EXISTING PIPING TO BE REMOVED
	 ∞	W&T	WASTE & TRAP
	-	_ co	LINE OR END CLEANOUT
	— ← — ← — ← — ← ← ← ← ← ← ← ← ← ← ← ← ←	FC O FCO	FLUSH FLOOR CLEANOUT
		J	PIPE CAP
			PIPE CONTINUATION
	o		PIPE UP THRU SLAB OF FLOOR ABOVE
	• •		PIPE DOWN THRU FLOOR SHOWN
		_	PIPE DROP
	J	_	PIPE RISE
		W&∨	WASTE & VENT PIPING
		SS	SOIL STACK
		WS	WASTE STACK
		VS	VENT STACK
		NTS	NOT TO SCALE
		ELEV.	ELEVATION
		FIN. FL.	FINISH FLOOR
		RL	RAIN LEADER
DEMADIAC		ETR	EXISTING TO REMAIN
REMARKS	4.440 W/ 00 0UE0V VIII	ETBR	EXISTING TO BE REMOVED
1. AMERICAN STANDARD SEAT #590 2. EVERCLEAN FINISH	I.IIO W/ SS CHECK HINGE		EXISTING TO BE REMOVED & REPLACED
3. PROVIDE WAX RING & BOLTS W/	TOILET FLANGE	CTE CWR	CONNECT TO EXISTING COLD WATER RISER
4 DDOVIDE UNVINE 5 040 00	That		HOT WATER RISER
1. PROVIDE MAXLINE 5-210-CK	IMV	11111	HOT WHEN MOEN

PLUMBING FIXTURE SCHEDULE

FIXTURE	DESCRIPTION		FIXTURE				FITTING				DELUB.	
NUMBER	DESCRIPTION	MANUFACTURER	MODEL	TYPE	SIZE	MANUFACTURER	TYPE	SUPPLY	TRAP	CARRIER	H/C MTD.	REMARKS
<u>P-1A</u>	WATER CLOSET FLOOR MOUNTED HANDICAPPED	AMERICAN STANDARD	MADERA 3641.001	FLOOR MOUNT 1.6 GAL FLUSH	1½" TOP EL®INGNIED ELONNUATED WHITE	SLOAN	SOLIS 8111-1.6	IPS	INTEGRAL	N/A	Y	1. AMERICAN STANDARD SEAT #5901.110 W/ SS CHECK HINGE 2. EVERCLEAN FINISH 3. PROVIDE WAX RING & BOLTS W/ TOILET FLANGE
<u>P-2</u>	LAVATORY	KOHLER	VERTICYL K-8189	UNDERMOUNT VANITY	17"x13 <i>½</i> "x5" WHITE	SLOAN	EAF-300-ISM	McGUIRE HEAVY DUTY HST02LK-IPS LOOSE KEY STOPS & STAINLESS STEEL BRAIDED SUPPLY RISERS	McGUIRE #8902-C-1¼"x1½" I.P.S. P-TRAP W/McGUIRE #HD 150A GRID STRAINER-ALL CHROME & HEAVY DUTY TYPE	WATTS TO SUITE	N	1. PROVIDE MAXLINE 5-210-CK TMV 2. PROVIDE SOAP DISPENSER BOBRICK-B-824 3. PROVIDE 120 VOLT POWER
<u>P-2A</u>	LAVATORY HANDICAPPED	AMERICAN STANDARD	LUCERNE 0355	WALL HUNG 2 HOLE MODIFIED TO ACCEPT SOAP DISPENSER	20 ½"x18 ¼" WHITE	SLOAN	EAF-300-ISM	McGUIRE HEAVY DUTY HST02LK-IPS LOOSE KEY STOPS & STAINLESS STEEL BRAIDED SUPPLY RISERS	McGUIRE #8902-C-1¼"x1½" I.P.S. P-TRAP W/McGUIRE #HD 155WC-C OFFSET GRID STRAINER-ALL CHROME & HEAVY DUTY TYPE	WATTS TO SUITE	Y	1. SEE ARCH DRAWINGS FOR MOUNTING HEIGHT 2. PROVIDE TRUBRO LAV GUARD KIT 3. PRROVIDE MAXLINE 5-210-CK TMV 4. PROVIDE SOAP DISPENSER BOBRICK B-824 5. PROVIDE 120 VOLT POWER
<u>P-3</u>	SHOWER	BEST BATH	LSS5038		50"x39"x77" W/ 2½" CURB	SYMMONS	ORIGIN LINE 9605-X- PLR-1.5-TRM	IPS	IPS TO SUITE	N/A	N	1. PROVIDE OPTION FROM SHOWER MANUFACTURER: a. GRAB BAR b. SOAP DISH c. CURTAIN ROD BRACKETS 2. PLUMBER TO PROVIDE: a. PROVIDE CURTAIN ROD & HOOKS b. PROVIDE SHOWER CURTAIN

WB) = WRIST BLADES (IR) = INFRARED (M) = MANUAL (L) = HANDICAP

Plumbing Legend, Schedules & **Notes**

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SALEM FIRE

DEPARTMENT

48 Lafayette St, Salem, MA, 01970

QUIETO CONSULTING ENGINEERS

DESIGN ENGINEERING SERVICES

CONSULTANT INFORMATION

OWNER INFORMATION

1 Bid Set (Not for Construction) 8.24.23

2023-005

As Noted SPQ

> CAD SPQ

> SPQ

July 5, 2023

Description

PROJECT REVISIONS

Job No.:

Designed By:

Drawn By:

Checked By:

Approved By:

Date: Scale:


PROJECT INFORMATION

PROJECT ARCHITECT

SEAL


SHEET NAME

P-0.1

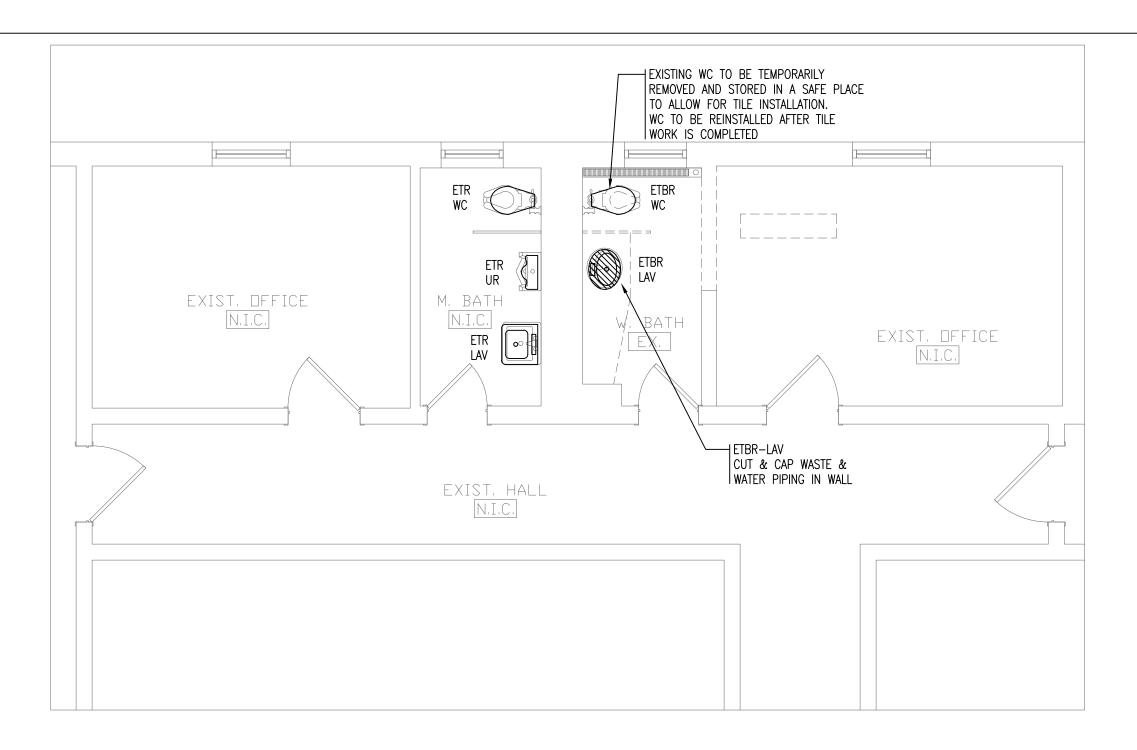



Demo Second Floor Plan SCALE: 1/4" = 1'-0"

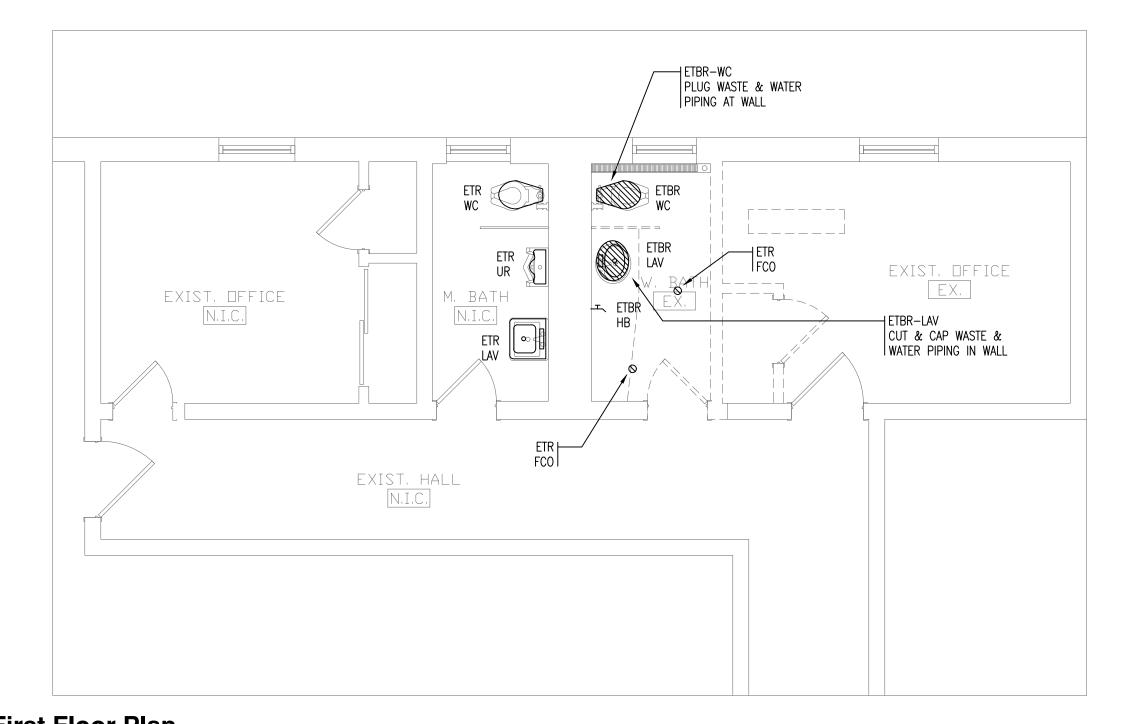



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PROJECT ARCHITECT

SALEM FIRE DEPARTMENT 48 Lafayette St, Salem, MA, 01970

PROJECT INFORMATION



CONSULTANT INFORMATION

OWNER INFORMATION


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PROJECT REVISIONS		No.	Description	Date
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	Job No.:	2023-005				
	Date:	July 5, 2023				
	Scale:	As Noted				
	Designed By:	SPQ				
	Drawn By:	CAD				
	Checked By:	SPQ				
	Approved By:	SPQ				
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Plumbing 1st & 2nd Floor Demolition Plan

SHEET NAME

P-1.1



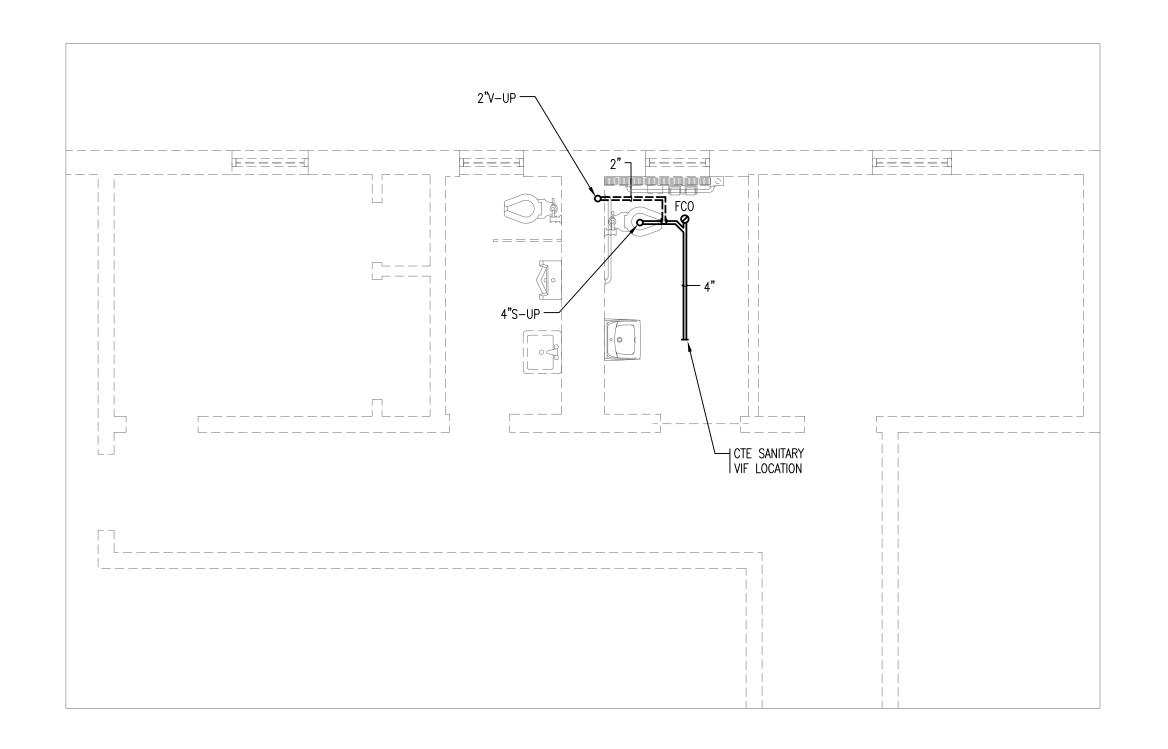

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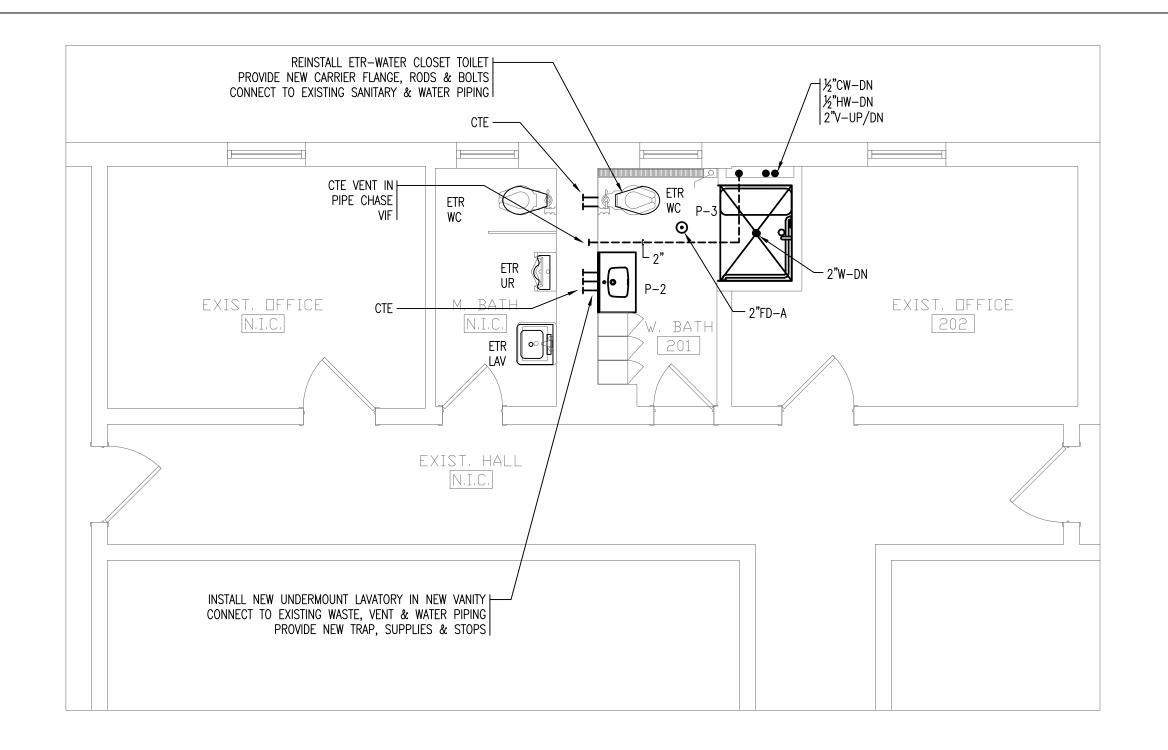
1	Bid Set (Not for Construction)	8.24.23	
No.	Description	Date	
PROJECT REVISIONS			

Job No.:	2023-005	
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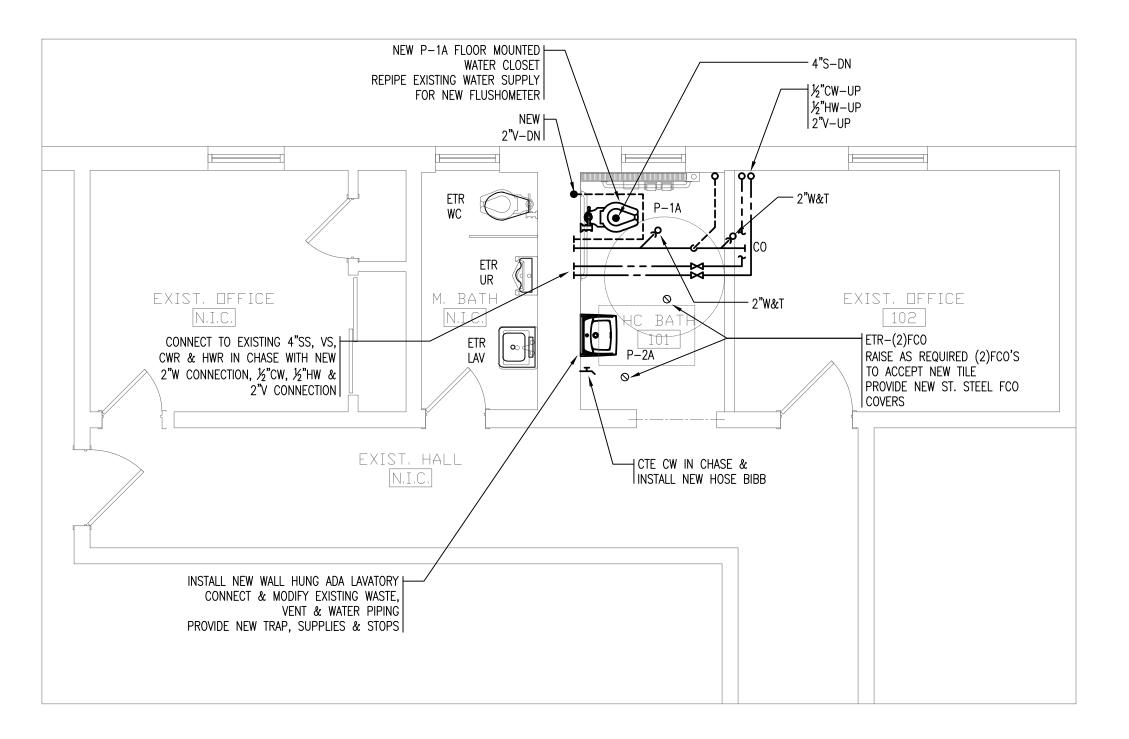
Plumbing Underslab New Plan

SHEET NAME

P-2.0







New First Floor Plan

SCALE: 1/4" = 1'-0"

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PROJECT ARCHITECT

SEAL

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Salem, MA, 01970

PROJECT INFORMATION



CONSULTANT INFORMATION

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	1	Bid Set (Not for Construction)	8.24.23
	No.	Description	Date
	PF	ROJECT REVISIONS	

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Drawn By:	CAD	
Checked By:	SPQ	
Approved By:	SPQ	
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Plumbing 1st & 2nd Floor New Plan

SHEET NAME

P-2.1

<u>PART 1 – GENERAL</u>

1.01 RELATED DOCUMENTS

A. ARCHITECTURAL GENERAL CONDITIONS AND SPECIAL CONDITIONS APPLY TO THIS SECTION.

1.02 WORK INCLUDED

- A. THE WORK COVERED BY THIS SECTION OF THE SPECIFICATION CONSISTS OF FURNISHING ALL MATERIALS, LABOR SUPERVISION, EQUIPMENT AND APPURTENANCES, TOOLS, PERMITS, AND SERVICE TO PERFORM ALL PLUMBING WORK, COMPLETE AND PLACE INTO APPROVED OPERATING CONDITIONS, INCLUDING ALL TESTS AND ADJUSTMENTS IN STRICT ACCORDANCE WITH THESE SPECIFICATIONS AND APPLICABLE DRAWINGS.
- B. THE PRINCIPAL WORK UNDER THIS SECTION SHALL INCLUDE, BUT WILL NOT BE LIMITED TO, THE FOLLOWING MAJOR ITEMS:
 - 1. WASTE AND VENT PIPING.
 - 2. COLD AND HOT WATER PIPING.
 - VALVES.
 - 4. HANGERS, SUPPORTS AND SLEEVES.

 - 5. INSULATION. 6. CORE DRILLING.
 - 7. PLUMBING FIXTURES.
 - 8. CO-ORDINATION W/ OTHER TRADES
 - 9. VALVE TAGS & CHARTS
 - 10. DEMOLITION
- RELATED WORK: THE FOLLOWING WORK IS NOT INCLUDED IN THIS SECTION AND IS TO BE PERFORMED UNDER THE DESIGNATED SECTIONS:
 - 1. HEATING, VENTILATION AND AIR CONDITIONING WORK.
 - 2. ELECTRICAL WORK.
 - CUTTING AND PATCHING.

1.03 SUBMITTALS

- SUBMIT COMPLETE SHOP DRAWINGS IN ACCORDANCE WITH THE PROVISIONS OF THE GENERAL CONDITIONS. SHOP DRAWINGS SHALL INCLUDE EQUIPMENT, PIPING, VALVES, HANGERS, SUPPORTS, INSULATION AND PLUMBING FIXTURES.
- B. SUBMIT SAMPLES IN ACCORDANCE WITH THE PROVISIONS OF THE GENERAL CONDITIONS.

1.04 PRODUCT DELIVERY, STORAGE AND HANDLING

- A. THE PLUMBING SUBCONTRACTOR SHALL BE RESPONSIBLE FOR HIS WORK UNTIL ITS COMPLETION AND FINAL ACCEPTANCE AND REPLACE ANY WORK OR MATERIALS THAT HAVE BEEN DAMAGED, LOST, OR STOLEN WITHOUT ADDITIONAL COST TO THE OWNER.
- B. MATERIALS AND FIXTURES SHALL BE PROPERLY PROTECTED AGAINST OBSTRUCTION AND DAMAGE.

1.05 JOB CONDITIONS

A. THE PLUMBING SUBCONTRACTOR SHALL VISIT THE SITE OF THE PROPOSED WORK AND SHALL FULLY ACQUAINT HIMSELF WITH THE CONDITIONS, CHARACTER AND EXTENT OF WORK REQUIRED.

1.06 GUARANTEE

A. SUBMIT ALL GUARANTEES IN ACCORDANCE WITH THE PROVISIONS OF THE GENERAL CONDITIONS.

1.07 RECORD DRAWINGS

A. PREPARE AND SUBMIT REPRODUCIBLE RECORD DRAWINGS, AND AUTOCAD DISC FILE AT END OF PROJECT.

1.08 CODES, ORDINANCES AND PERMITS

- A. ALL WORK AND MATERIALS ARE TO COMPLY IN EVERY RESPECT WITH THE LOCAL BUILDING LAWS AND MASSACHUSETTS STATE PLUMBING CODE, AND SUCH APPLICABLE BUILDING LAWS AND REGULATIONS ARE TO BE CONSIDERED AS PART OF THESE SPECIFICATIONS.
- THE PLUMBING SUBCONTRACTOR IS TO GIVE ALL REQUISITE NOTICES, FILE ALL REQUISITE PLANS RELATING TO HIS WORK WITH THE PROPER ALITHORITIES AND IS TO SECURE ALL PERMITS AND PAY ALL FEES FOR SAME, IF ANY WORK IS PERFORMED AND CHANGES ARE NECESSARY TO CONFORM TO THE ORDINANCES, THESE CHANGES SHALL BE MADE AT THE PLUMBING SUBCONTRACTOR'S EXPENSE.
- C. THE DRAWINGS AND SPECIFICATIONS SHALL BE FOLLOWED WHEN IN EXCESS OF THE MINIMUM REQUIREMENTS OF THE CODE.

PLUMBING SPECIFICATIONS

1.09 DRAWINGS AND SPECIFICATIONS

- THE DRAWINGS AND THESE SPECIFICATIONS ARE COMPLEMENTARY EACH TO THE OTHER, AND ANY LABOR OR MATERIALS CALLED FOR BY EITHER, WHETHER OR NOT BY BOTH, SHALL BE FURNISHED AND INSTALLED BY THIS SUBCONTRACTOR.
- THE DRAWINGS ARE DIAGRAMMATIC AND INDICATE THE VARIOUS SYSTEMS AND PIPING. DUE TO THE SMALL SCALE OF THE DRAWINGS, IT IS NOT POSSIBLE TO INDICATE ALL OFFSETS, FITTINGS, DEVICES AND ACCESSORIES WHICH MAY BE REQUIRED. THE PLUMBING SUBCONTRACTOR SHALL EXAMINE THE ENTIRE SET OF CONTRACT DRAWINGS AND CAREFULLY INVESTIGATE THE STRUCTURE AND FINISH CONDITIONS AFFECTING ALL HIS WORK AND SHALL ARRANGE SUCH WORK ACCORDINGLY FOR THE COMPLETE SATISFACTORY OPERATION OF ALL SYSTEMS PROVIDING SUCH FITTINGS, VALVES, DEVICES AND ACCESSORIES AS MAY BE REQUIRED TO MEET SUCH CONDITIONS. WORK SHALL BE PERFORMEDIN ACCORDANCE WITH THE BEST PRACTICES OF THE TRADE AND TO THE SATISFACTION OF THE ARCHITECT AND OWNER AT NO ADDITIONAL COST TO EITHER.

1.10 COORDINATION OF TRADES

THE PLUMBING SUBCONTRACTOR SHALL PROVIDE ALL REQUIRED COORDINATION AS REQUIRED BY THE CONTRACTOR.

1.11 OPERATING INSTRUCTIONS AND MAINTENANCE MANUAL

- INSTRUCT TO THE OWNER'S SATISFACTION SUCH PERSONS AS THE OWNER DESIGNATES, IN THE PROPER OPERATION AND MAINTENANCE OF THE SYSTEMS AND THEIR PARTS.
- B. THIS SUBCONTRACTOR SHALL SUBMIT TO THE ARCHITECT FOR APPROVAL, THREE (3) SETS OF OPERATING AND INSTRUCTIONAL MANUALS, SPARE PARTS LISTS, DRAWINGS, MANUFACTURER'S BULLETINS AND OTHER PERTINENT DATA OF ALL EQUIPMENT FURNISHED UNDER THIS CONTRACT. EACH SET SHALL BE ENCLOSED IN A SUITABLE HARD COVER BINDER.
- C. PROVIDE NAME, ADDRESS AND TELEPHONE NUMBERS OF THE MANUFACTURER'S REPRESENTATIVE AND SERVICE COMPANY OR EACH PIECE SO THAT SERVICE PARTS CAN BE READILY OBTAINED.

1.12 CLEANUP

A. AFTER COMPLETION OF THE WORK, ALL TOOLS AND OTHER EQUIPMENT SHALL BE REMOVED FROM THE BUILDING, ALL EXCESS MATERIALS SHALL BE REMOVED AND THE BUILDING LEFT BROOM CLEAN, ALL MATERIALS AND EQUIPMENT SURFACES SHALL BE CLEANED AND POLISHED IN ACCORDANCE WITH THE FINISH OF THE MATERIAL.

1.13 <u>IDENTIFICATION</u>

- A. ALL STENCILING OF PIPING, MATERIALS AND EQUIPMENT AS OUTLINED HEREINAFTER FOR IDENTIFICATION PURPOSES SHALL BE PERFORMED BY THIS SUBCONTRACTOR.
- B. THE STENCILING SHALL BE PAINTED ON THE APPARATUS IN FULL VIEW AND SHALL BE A COLOR THAT IS IN SHARP CONTRAST WITH THE BACKGROUND. COLOR CODING TO BE IN ACCORDANCE WITH THE STANDARDS.
- C. BEFORE STENCILING IS APPLIED, THE APPARATUS SHALL BE THOROUGHLY CLEANED AND PAINTED, IF POSSIBLE.
- D. LETTERS SHALL NOT BE LESS THAN 1 ½" IN HEIGHT. ARROWS SHALL NOT BE LESS THAN 9" LONG.
- E. ALL WATER PIPING SYSTEMS EXPOSED AND ABOVE FURRED CEILINGS SHALL BE IDENTIFIED AT INTERVALS OF APPROXIMATELY 20' AND AT EACH CHANGE OF DIRECTION.
- F. IN LIEU OF STENCILING, PIPING SYSTEMS MAY BE IDENTIFIED WITH APPROVED SNAP-ON COVERS DESIGNATING SERVICES AND DIRECTION OF FLOW. LOCATION OF IDENTIFICATION COVERS SHALL BE NEAR ACCESS PANELS WHEREVER POSSIBLE AND ON BOTH SIDES OF VALVES. THE MARKERS SHALL BE AS MANUFACTURED BY W.H. BRADY CO., WESTLINE PRODUCTS, SETON NAMEPLATE CO., OR APPROVED EQUAL.

1.14 TESTING OF PIPING SYSTEMS

- A. ALL PIPING SYSTEMS SHALL BE SUBJECTED TO TESTING WITH WATER OR AIR AS NOTED AND SHALL HOLD TIGHT AT THE PRESSURE HEAD STATED FOR THE TIME INTERVAL REQUIRED WITHOUT ADDING AIR OR WATER. WHILE ANY SYSTEM IS BEING TESTED, REQUIRED HEAD OF PRESSURE SHALL BE MAINTAINED UNTIL ALL JOINTS ARE INSPECTED.
- B. ALL TESTS SHALL BE WITNESSED BY THE LOCAL INSPECTOR HAVING JURISDICTION AND THE ARCHITECT/ENGINEER, WITH 48-HOUR NOTICE GIVEN THESE AUTHORITIES.
- C. ALL EQUIPMENT, MATERIALS AND LABOR REQUIRED FOR TESTING ANY OF THE VARIOUS SYSTEMS OR ANY PART THEREOF SHALL BE FURNISHED BY THIS SUBCONTRACTOR.
- D. WATER PIPING SYSTEMS: TEST ALL SECTIONS WITH AIR TO AT LEAST 150 PSI FOR A PERIOD
- E. SANITARY SYSTEM: TEST ALL SECTIONS WITH WATER TO AT LEAST 10-FOOT HEAD OF WATER.
- DEFECTIVE WORK: IF INSPECTION OR TEST SHOWS DEFECTS, SUCH DEFECTIVE WORK OR MATERIAL SHALL BE REPLACED, INSPECTION AND TESTS SHALL BE REPEATED. ALL REPAIRS TO PIPING SHALL BE MADE WITH NEW MATERIAL. NO CAULKING OF SCREWED JOINTS OR HOLES WILL BE ACCEPTABLE.

1.15 VALVE TAGS

A. PROVIDE VALVE TAGS ON ALL VALVES & PROVIDE VALVE TAGS ON RECORD DRAWINGS. PROVIDE VALVE TAGS CHART IN O&M MANUAL.

PART 2 - PRODUCTS

2.01 MATERIALS

- A. SOIL PIPE AND FITTINGS:
 - 1. ABOVE GROUND SOIL PIPE AND FITTINGS, WASTE, & VENT PIPING: 2. SERVICE WEIGHT NO-HUB CAST IRON W/HUSKEY SD-4000 CLAMPS ABOVE GROUND.
- B. SOIL PIPE AND FITTINGS BURIED SOIL, WASTE, & VENT PIPING 1. SHALL BE SERVICE WEIGHT CAST IRON WITH PUSH ON NEOPRENE GASKETS.
- COPPER TUBING AND FITTINGS (TYPE L): TUBING TO BE TYPE L HARD TEMPER WITH WROUGHT COPPER FITTINGS. ALL JOINTS SHALL BE PRO PRESS FITTINGS.
- D. WATER VALVES: BALL VALVES SHALL BE ALL BRONZE DESIGNED FOR 200 PSI WATER.
- HANGERS AND SUPPORTS: ALL PIPING SHALL BE SUPPORTED FROM THE BUILDING STRUCTURE BY MEANS OF APPROVED HANGERS AND SUPPORTS. PIPING SHALL BE SUPPORTED TO MAINTAIN REQUIRED GRADING AND PITCHING OF LINES. HANGERS FOR UNCOVERED (UNINSULATED) COPPER PIPING SHALL BE FACTORY APPLIED PLASTIC COATED STEEL CLEVIS HANGERS.
- SLEEVES AND ESCUTCHEONS: APPROVED SLEEVES FOR THE PASSAGE OF ALL SYSTEMS PASSING THROUGH WALLS, FLOORS AND PARTITIONS SHALL BE FURNISHED AND SET BY THIS SUBCONTRACTOR.
 - 1. SLEEVES SHALL BE ONE PIECE GALVANIZED SCHEDULE 40 STEEL PIPING.
 - 2. ESCUTCHEONS SHALL BE CHROME PLATED HEAVY BRASS FITTING THE PIPE PASSING THROUGH FINISHED FLOOR, WALL OR CEILING AND SHALL BE SET IN MASTIC AT ALL SLEEVES THROUGH FLOORS.
- INSULATION MATERIAL AND SCOPE: ALL NEW WATER PIPING, FITTINGS AND VALVES SHALL BE INSULATED.
 - 1. PIPE INSULATION = FIBERGLASS.
 - 2. FITTINGS AND VALVES INSULATION = MOLDED OR FABRICATED FITTING COVERS OF EQUAL THICKNESS AND IDENTICAL IN COMPOSITION TO ADJACENT PIPE INSULATION.
 - 3. ALL MATERIALS, INCLUDING VAPOR BARRIER JACKETS, GLASS CLOTH JACKETS, ADHESIVES, ETC., SHALL BE FIRE RETARDANT.
 - 4. INSULATION THICKNESS = MINIMUM THICKNESS SHALL BE DOMESTIC COLD PIPING @ 1/2" THICK, HOT WATER SUPPLY AND RETURN PIPING @ 1" THICK.
 - 5. FINISH = VAPOR BARRIER JACKET ON ALL WATER PIPING WHICH SHALL NOT BE PUNCTURED OR DISTURBED. ALL SERVICE JACKET SHALL BE FURNISHED AND FITTINGS SHALL HAVE PVC JACKET.

H. INSULATION APPLICATION

- 1. GENERAL: ALL INSULATION SHALL BE INSTALLED IN STRICT ACCORDANCE WITH THE MANUFACTURER'S RECOMMENDATIONS AND SHALL BE APPLIED BY A QUALIFIED INSULATION CONTRACTOR.
- 2. PIPING: PIPE INSULATION SHALL BE INSTALLED WITH VAPOR BARRIER JACKETS DRAWN TIGHT AND FIRMLY SEALED TO ASSURE A POSITIVE VAPOR SEAL. END JOINTS SHALL BE COVERED WITH 4" WIDE BUTT STRIPS OF MATERIAL IDENTICAL TO VAPOR BARRIER JACKETS, AND THEY SHALL BE DRAWN TIGHT AND SECURELY SEALED. THE USE OF STAPLES, BANDS, ETC., TO SECURE INSULATION WILL NOT BE ACCEPTABLE.
- 3. FITTINGS AND VALVES: MOLDED INSULATION ON FITTINGS AND VALVE BODIES SHALL BE SAME THICKNESS AS ADJACENT COVERING AND FINISHED NEATLY TO MATCH THE ADJACENT PIPE INSULATION.
- 4. HANGERS AND SADDLES: SPECIAL HIGH DENSITY INSERTS OF CALCIUM SILICATE, CELLULAR GLASS OR OTHER APPROVED MATERIAL OF THE SAME THICKNESS AS ADJACENT INSULATION SHALL BE INSTALLED AT POINTS OF HANGER SUPPORT. INSULATION INSERTS SHALL BE EITHER 180 DEGREES OF 260 DEGREES AND NOT LESS THAN 18" IN LENGTH. THE ENTIRE INSERT SHALL BE COVERED WITH VAPOR BARRIER FACING OF THE SAME APPEARANCE AND QUALITY AS THE FACING ON THE ADJACENT COVERING, INSULATION AT ANCHORS AND SUPPORTS SHALL BE NEATLY CUT AND FITTED.
- I. PLUMBING FIXTURES SEE FIXTURE SCHEDULE ON DRAWINGS.

PART 3 - EXECUTION

3.01 WASTE AND VENT PIPING

A. FURNISH AND INSTALL A COMPLETE NEW WASTE AND VENT PIPING SYSTEM AS REQUIRED BY APPLICABLE CODES.

3.02 WATER PIPING

A. FURNISH AND INSTALL A COMPLETE NEW GENERAL PURPOSE COLD AND HOT WATER PIPING, VALVES AND CONNECTIONS TO ALL PLUMBING FIXTURES AS REQUIRED BY APPLICABLE CODES.

3.03 DEMOLITION

- A. THIS SUBCONTRACTOR SHALL DISCONNECT AND REMOVE ALL EXISTING WATER, SANITARY, VENT, & CONDUCTOR PIPING AND EQUIPMENT IN THE BUILDING INDICATED WHEN THE PHASING SCHEDULE ALLOWS SAME. THESE SYSTEMS SHALL BE RECONNECTED TO WHERE REQUIRED WITH NEW PIPING SERVING SAME. SPECIAL ATTENTION MUST BE GIVEN TO THE REQUIRED PHASING OF THE CONSTRUCTION AS IT RELATES TO PLUMBING.
- DISCONNECTED AND REMOVED EQUIPMENT AND PIPING SHALL BE REMOVED OFF THE SITE AND DISPOSED OF LEGALLY BY THIS SUBCONTRACTOR, EXCEPT WHAT THE OWNER WISHES TO RETAIN. THIS SUBCONTRACTOR SHALL NEATLY STOCKPILE MATERIALS AS DIRECTED BY THE CONSTRUCTION MANAGER UNTIL MATERIAL CAN BE DISPOSED OF AS REQUIRED.
- C. ALL DISCONNECTED AND REMOVED PIPING SHALL BE PLUGGED OR CAPPED BACK AT MAIN OR RISER. ALL UNUSED BRANCH PIPING MUST BE REMOVED. EXISTING RISERS WHICH ARE EXPOSED DUE TO WALL DEMOLITION MUST ALSO BE REMOVED IF THEY ARE NO LONGER NEEDED. REMOVE ALL UNUSED VALVES, FITTINGS AND BRANCHES.
- D. DURING DEMOLITION WORK THIS SUBCONTRACTOR SHALL COORDINATE WITH THE OWNER'S SAFETY OFFICER REGARDING REMOVAL OF PIPE AND EQUIPMENT IN HAZARDOUS AREAS.

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|Bid Set (Not for Construction) | 8.24.23 Description Date PROJECT REVISIONS

Job No. 2023-005 Date: July 5, 2023 Scale As Noted SPQ Designed By: CAD Drawn By: SPQ Checked By: SPQ Approved By: Copyright © by Seger Architects, Inc. All rights reserved.

Plumbing Specifications

SHEET NAME

P-3.0